

APPROVED
Building Engineer
Brimmer Municipal Corporation
Date: 2/21/10

- Minimum covering at building materials stored at the construction site, this is done daily.
- Using water spray or sprayers to keep the dust down during activities with an covering, plastering, troweling concrete and paving activities.
- Washing the wheels of vehicles leaving the site, if they are carrying mud or water.
- Putting up solid barriers around the site.
- Properly covering trucks & vehicles that enter and leave the site during building materials and building activities.
- Cleaning and washing the road and equipment adjacent to the site at frequent intervals.
- Using dust traps, sweeping or other means to reduce the amount of dust that enters the street.
- Maintaining works activities at all times which cause excessive dust emissions and a range of nuisance substances.

- During construction activities, the following measures shall be taken to reduce the level of dust:
- 1) Building sites for Brimmer Municipal Corporation shall have to be covered.
 - 2) For activities of water that the make, check, wash or the vehicles in general.
 - 3) For concrete & cement concrete.
 - 4) For concrete & cement concrete, the concrete shall be covered to the extent possible.
 - 5) For concrete & cement concrete, the concrete shall be covered to the extent possible.
 - 6) For concrete & cement concrete, the concrete shall be covered to the extent possible.
 - 7) For concrete & cement concrete, the concrete shall be covered to the extent possible.

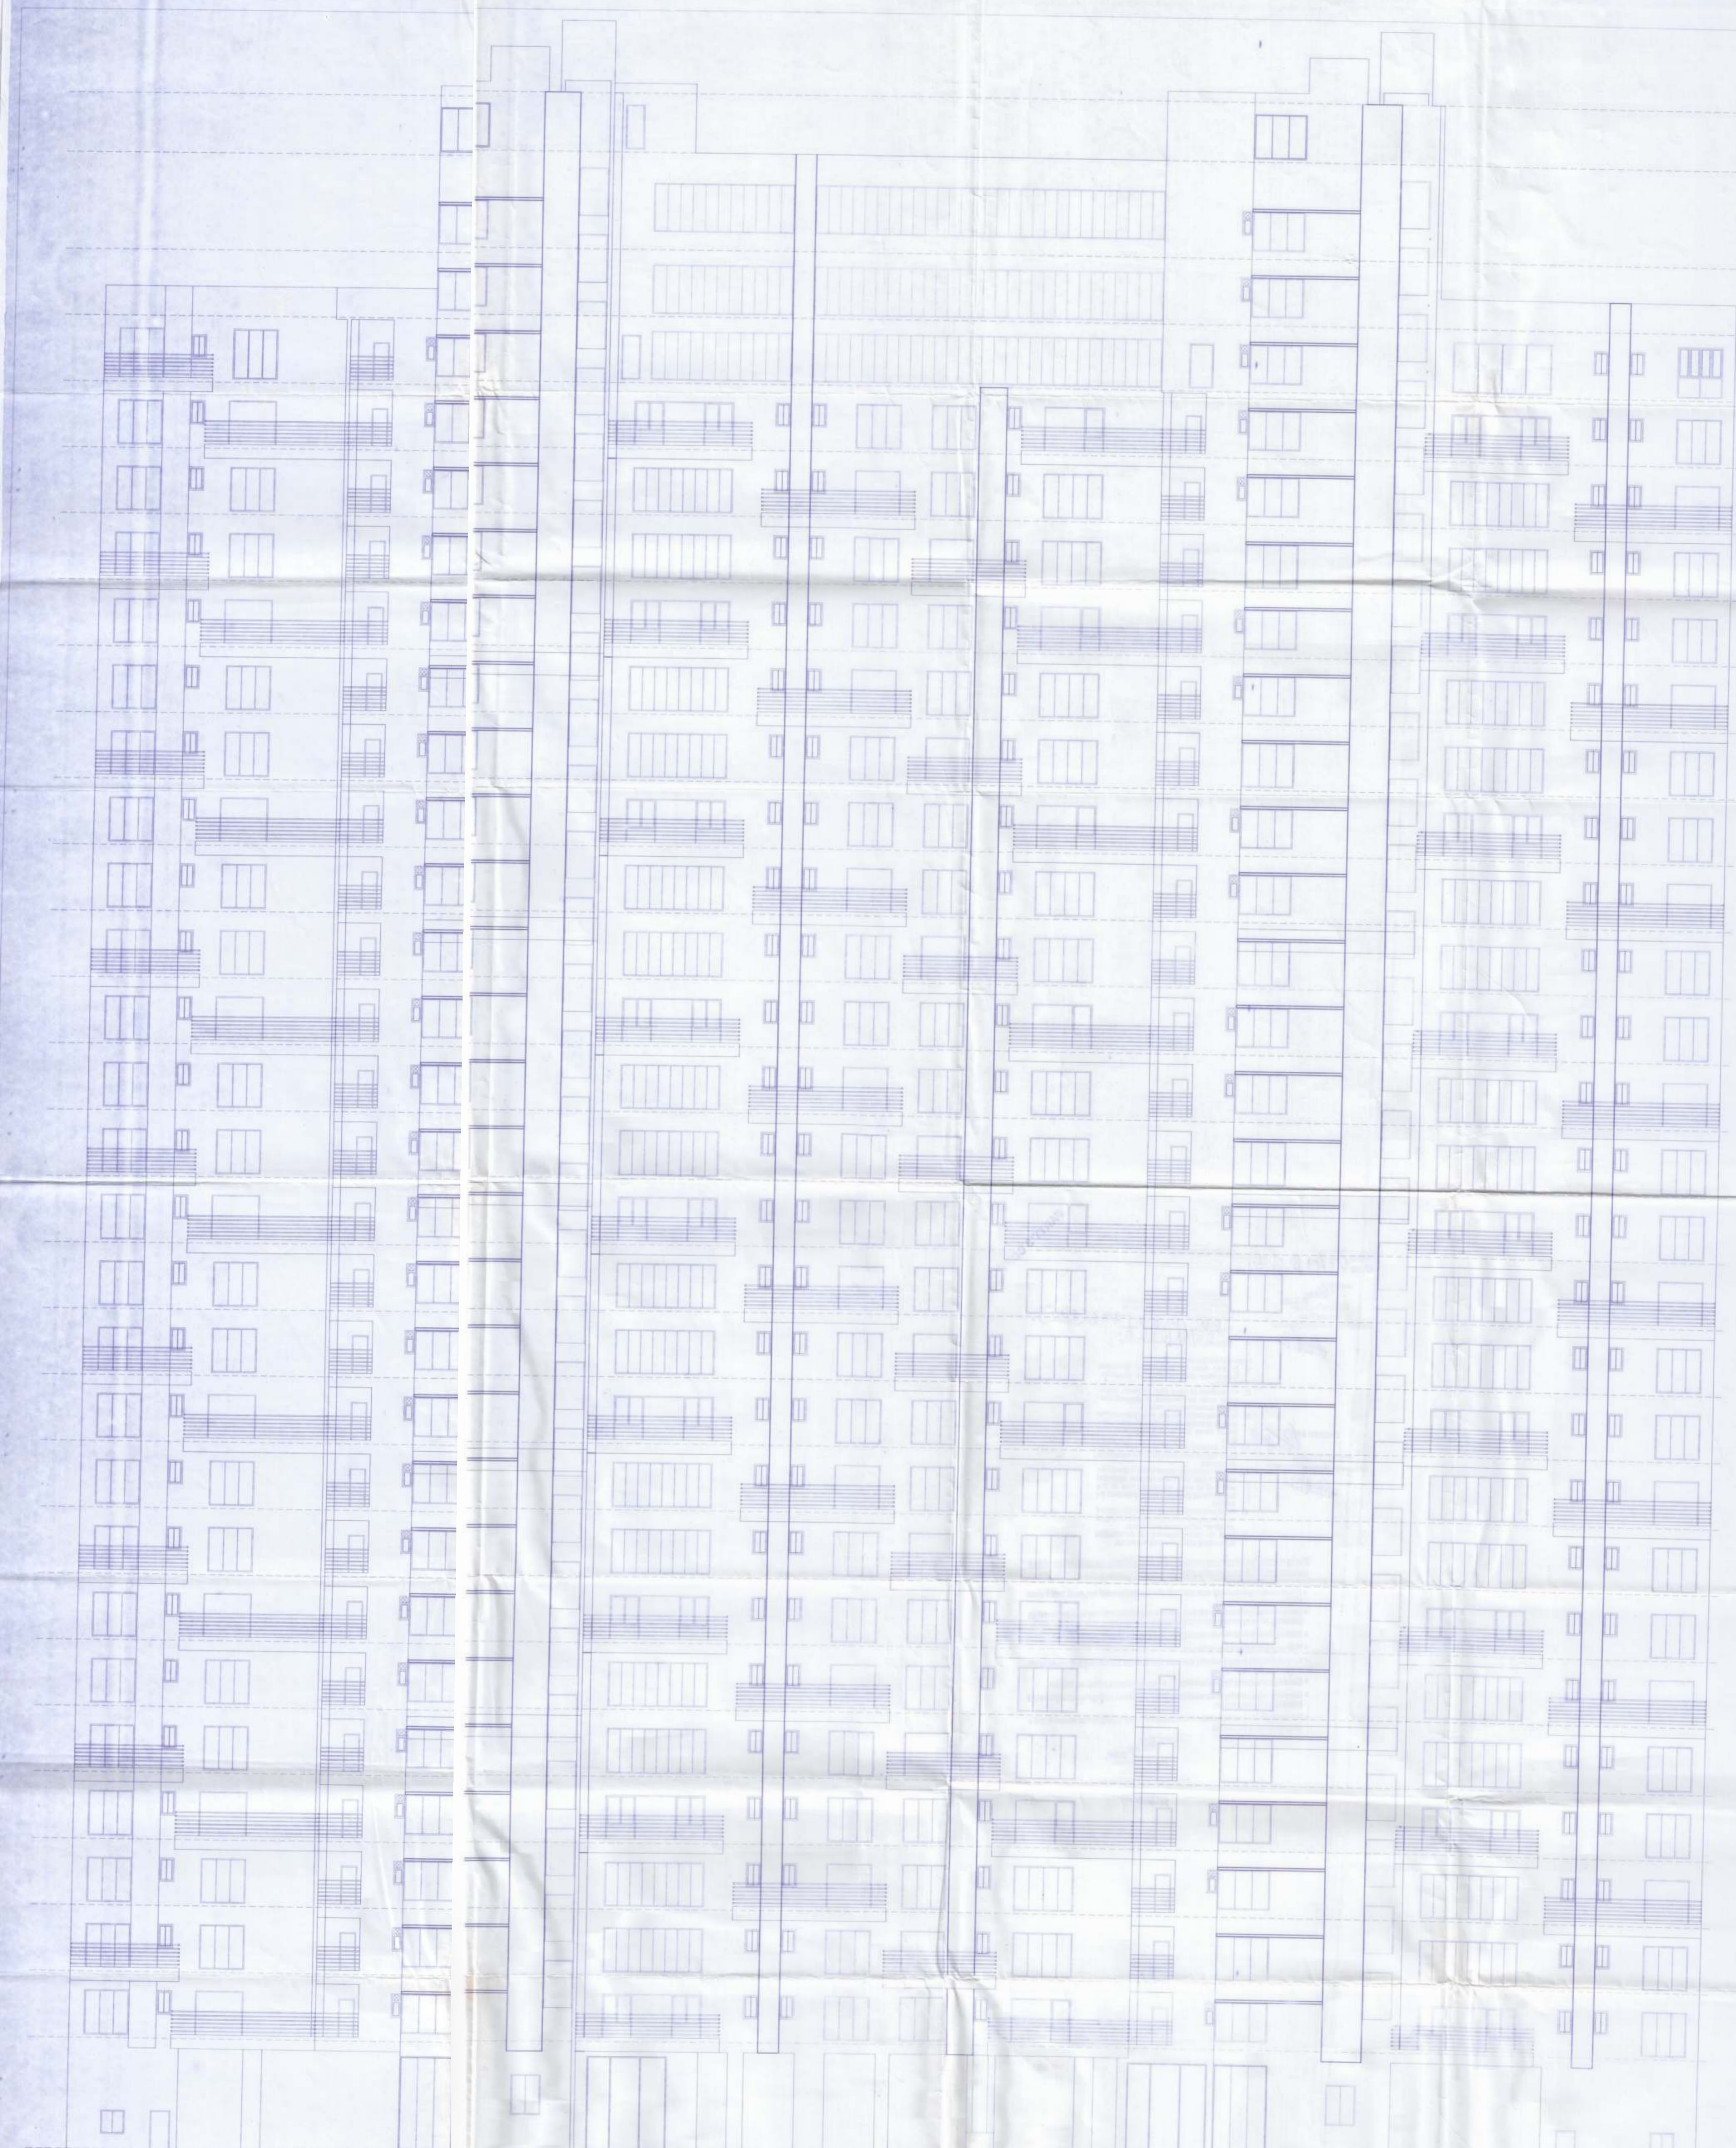
CHECKED BY
Date: 2/21/10

Valid Up to 02/21/10 09:30
Date: 2/21/10

PARTY'S COPY

ANY DEVIATION SHALL BE REPORTED TO THE DEPARTMENT

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NORTH SIDE ELEVATION

PROJECT : PROPOSED 28+G+26 STORED RESIDENTIAL BUILDING UNDER MOUZAMAHESHTHAN J.L. NO-18, LR DAG NO-462, 504, 505, P.S. (NEW)-ELECTRONIC COMPLEX, P.S. (OLD)-RAJARHAT S.S. - BIDHANNAGAR 35T-24 PARGANAS (N), KOLKATA - 700102 SITE PLAN NO. - 10/119-20 DATE : 05.08.2019		TITLE NORTH SIDE ELEVATION		CERTIFICATE OF OWNER : Certified that I have gone through the building rules for the above project and also undertake to and after the construction of the building	
DRG. NO. IN/1256/CORP/SEC/ELEV/11	NORTH	SCALE 1:100	DRAWN BY S.D.B.	MERLIN PROJ 'S LTD. Architects & Engineers Kolkata	
DATE 12.07.2019	CHKD BY S.M.	DATE 12.07.2019	CHKD BY S.M.	SIGNATURE OF OWNER	
JOB NO. IN/1256	APVD BY S.M.	DESIGNED BY T.MATE	ISSUE STATUS SANCTION	SIGNATURE OF ARCHITECT	

CERTIFICATE OF THE ARCHITECT :
 I DO HEREBY CERTIFY THAT PLANS, ELEVATIONS AND SECTIONS AND OTHER STRUCTURAL DETAILS OF THE PROPOSED BUILDING HAVE BEEN PREPARED IN CONFORMANCE WITH ALL RELEVANT REGULATIONS UNDER THE WEST BENGAL MUNICIPAL BUILDING RULES, 1911. THIS ALSO I HEREBY CERTIFY THAT ALL RELEVANT NOTIFICATION CERTIFICATES FROM THE RESPECTIVE AUTHORITIES SUCH AS FIRE AND EMERGENCY SERVICES DEPARTMENT, AIRPORT AUTHORITY'S, POLLUTION CONTROL BOARD, AND TELECOMMUNICATION DEPARTMENT (T.C.) AS APPLICABLE IN THIS REGARD, ARE ALSO ENCLOSED WITH THE APPLICATION FOR SEEKING APPROVAL OF THE PLAN TO CONSTRUCT OF THE BUILDING ON THE SAID PLOT.

Sanjay Mandal
 Sanjay Mandal
 CIVIL ARCHITECT
 NAME OF THE ARCHITECT
 SANJAY MANDAL
 C.O.A. REG. NO. CAP/98/23821

CERTIFICATE OF THE STRUCTURAL ENGINEER :
 WE HEREBY CERTIFY THAT THE FOUNDATION AND SUPERSTRUCTURE OF THE PROPOSED BUILDING HAS BEEN PERSONALLY INSPECTED AND SO DESIGNED BY US WITH CARE SUCH FOUNDATION AND SUPER STRUCTURE SAFE IN ALL RESPECTS INCLUDING THE CONSIDERATION OF BEARING CAPACITY AND SETTLEMENT OF SOIL AND OTHER CONDITIONS, IF ANY CONSIDERING TO ALL APPLICABLE CODES OF PRACTICE AND NATIONAL BUILDING CODES.

Arpit Aggarwal
 ARPT AGGARWAL
 B.E. CIVIL ENGINEER
 B.E. IN STRUCTURAL ENGINEERING
 C.O.A. REG. NO. CAP/98/23821
 SIGNATURE OF STRUCTURAL ENGINEER

CERTIFICATE OF THE GEO-TECHNICAL ENGINEER :
 It is certified that the comprehensive Geo-technical Report on soil investigation has been prepared by me for design and calculation of the foundation to be adopted for the structure. I have also checked the nature of the soil at the site so that foundation is extended to no inappropriate depth that has been proposed in the Geo-technical Report.

Utpal Sankar
 UTPAL SANKAR
 B.E. IN CIVIL ENGINEERING
 B.E. IN GEOTECHNICAL ENGINEERING
 C.O.A. REG. NO. CAP/98/23821
 SIGNATURE OF GEO-TECHNICAL ENGINEER

CERTIFICATE OF STRUCTURAL REVIEWER :
 I DO HEREBY CERTIFY THAT THE BUILDING SITE PROPOSED FOR CONSTRUCTION AND BEEN VISITED BY ME AND ALL THE SPECIFIC, DIMENSION, SOIL TEST REPORT AND LOAD TEST REPORT AND LOAD TEST RESULTS FOR FOUNDATION AND SUPERSTRUCTURE, HAVE BEEN FOR REVIEWED CONSIDERING TO ALL APPLICABLE CODES OF PRACTICE AND NATIONAL BUILDING CODE AND IT IS FOUND THAT EVERYTHING IS COMPLETED IN ORDER AND THE PROPOSED FOUNDATION AND SUPER STRUCTURE ARE SAFE IN ALL RESPECTS.

Utpal Sankar
 UTPAL SANKAR
 B.E. IN CIVIL ENGINEERING
 B.E. IN GEOTECHNICAL ENGINEERING
 C.O.A. REG. NO. CAP/98/23821
 SIGNATURE OF STRUCTURAL REVIEWER

ARCHITECT  **INNATE**

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