


SCHEDULE OF OVER HEAD RESERVOIR


| NO. | UNIT | QTY | UNIT PRICE | TOTAL |
|-----|------|-----|------------|--------|
| 1 | CU M | 215 | 1500 | 322500 |
| 2 | NO | 1 | 1500 | 1500 |
| 3 | NO | 1 | 1500 | 1500 |
| 4 | NO | 1 | 1500 | 1500 |
| 5 | NO | 1 | 1500 | 1500 |
| 6 | NO | 1 | 1500 | 1500 |
| 7 | NO | 1 | 1500 | 1500 |
| 8 | NO | 1 | 1500 | 1500 |
| 9 | NO | 1 | 1500 | 1500 |
| 10 | NO | 1 | 1500 | 1500 |
| 11 | NO | 1 | 1500 | 1500 |
| 12 | NO | 1 | 1500 | 1500 |
| 13 | NO | 1 | 1500 | 1500 |
| 14 | NO | 1 | 1500 | 1500 |
| 15 | NO | 1 | 1500 | 1500 |
| 16 | NO | 1 | 1500 | 1500 |
| 17 | NO | 1 | 1500 | 1500 |
| 18 | NO | 1 | 1500 | 1500 |
| 19 | NO | 1 | 1500 | 1500 |
| 20 | NO | 1 | 1500 | 1500 |
| 21 | NO | 1 | 1500 | 1500 |
| 22 | NO | 1 | 1500 | 1500 |
| 23 | NO | 1 | 1500 | 1500 |
| 24 | NO | 1 | 1500 | 1500 |
| 25 | NO | 1 | 1500 | 1500 |
| 26 | NO | 1 | 1500 | 1500 |
| 27 | NO | 1 | 1500 | 1500 |
| 28 | NO | 1 | 1500 | 1500 |
| 29 | NO | 1 | 1500 | 1500 |
| 30 | NO | 1 | 1500 | 1500 |
| 31 | NO | 1 | 1500 | 1500 |
| 32 | NO | 1 | 1500 | 1500 |
| 33 | NO | 1 | 1500 | 1500 |
| 34 | NO | 1 | 1500 | 1500 |
| 35 | NO | 1 | 1500 | 1500 |
| 36 | NO | 1 | 1500 | 1500 |
| 37 | NO | 1 | 1500 | 1500 |
| 38 | NO | 1 | 1500 | 1500 |
| 39 | NO | 1 | 1500 | 1500 |
| 40 | NO | 1 | 1500 | 1500 |
| 41 | NO | 1 | 1500 | 1500 |
| 42 | NO | 1 | 1500 | 1500 |
| 43 | NO | 1 | 1500 | 1500 |
| 44 | NO | 1 | 1500 | 1500 |
| 45 | NO | 1 | 1500 | 1500 |
| 46 | NO | 1 | 1500 | 1500 |
| 47 | NO | 1 | 1500 | 1500 |
| 48 | NO | 1 | 1500 | 1500 |
| 49 | NO | 1 | 1500 | 1500 |
| 50 | NO | 1 | 1500 | 1500 |

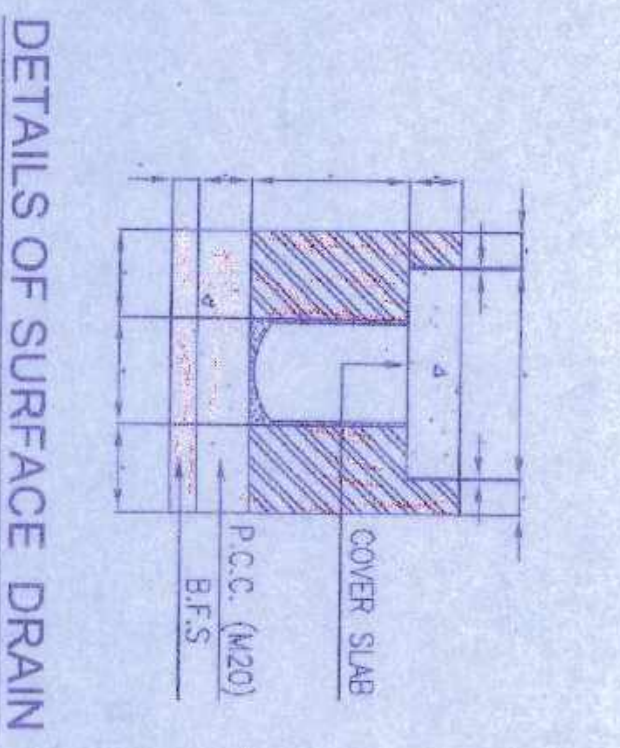

AREA STATEMENT

TOTAL AREA OF THE LAND : 408.88 SQ.M.
 TOTAL AREA OF THE BUILDING : 338.22 SQ.M.
 PROP. FIRST FLOOR COVD. AREA : 338.22 SQ.M.
 PROP. SECOND FLOOR COVD. AREA : 338.22 SQ.M.
 PROP. THIRD FLOOR COVD. AREA : 338.22 SQ.M.
 TOTAL PROP. COVD. AREA : 1356.88 SQ.M.
 HEIGHT OF THE BUILDING : 11.0 Mtr.
 G.L. TO P.L. : 0.15 Mtr.

5/20 (08-19)
(FLAT)

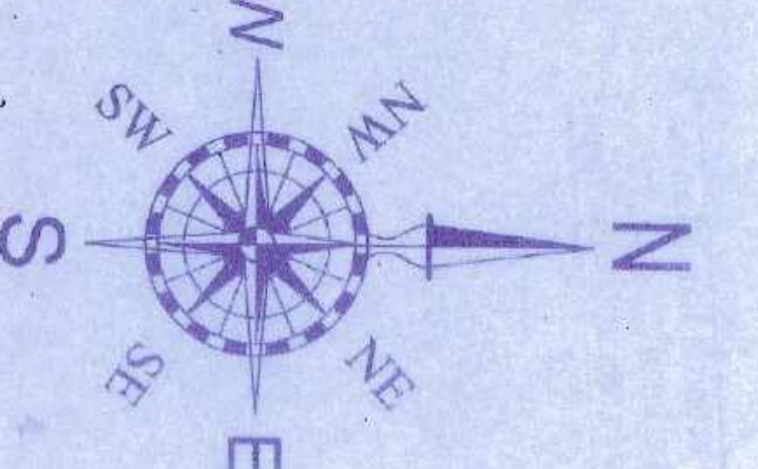

SHEET NO. - 3/3

- NOTES & SPECIFICATIONS**
- ALL DIMENSIONS ARE IN M.M. UNLESS OTHERWISE SPECIFIED.
 - ALL DIMENSIONS FROM THIS DRAWING IS UNDER OWN.
 - ALL OUTLET WALL 250TH IN 15 & INLET WALL 125TH.
 - IN 1:4 SAND CEMENT MORTAR.
 - CONCRETE GRADE 150 BUT MAX NOT LESS THAN 1:1.5:3.
 - WALLMAT 14.8 FLOOR P.C.C. 1:3:6.
 - ALL DEVELOPMENT LENGTH ARE 20 TIMES DIA OF BARS.
 - ROOF LINE TERRACING (2:1).
 - FLOORING = 40THK. 1:2:4.

STATEMENT - PROPOSED G+H+I
 STORED RESIDENTIAL BUILDING OF AT
 L.R. DAG NO - 2740 L.R. KHATIAN NO. -
 5655, 5656 & 6653, MOUZA - BALLY, Q.L. NO. -
 09, HOLDING NO - 560/433/105/4560.
 MOHALA - KAJIDANGA, IN WARD NO. - 05,
 UNDER - HOOGHLY CHINSURAH
 MUNICIPALITY, P.S. - CHINSURAH, DIST -
 HOOGHLY.

DOORS & WINDOWS SCHEDULES






| TYPE | WIDTH | HEIGHT | DESCRIPTION |
|------|----------------|--------|-----------------------|
| D1 | 1200 | 1950 | PANELLED DOOR |
| D2 | 900 | 1950 | PANELLED DOOR |
| D3 | 825 | 1950 | PANELLED DOOR |
| D4 | 750 | 1950 | P.V.C. DOOR |
| D5 | 1500 | 1950 | COLLAPSIBLE GATE |
| D6 | TO SIT AT SITE | | MS SHUTTER WITH GLASS |
| D7 | TO SIT AT SITE | | DOOR WINDOW |
| D8 | 1500 | 1200 | WINDOW SHUTTER |
| D9 | 1000 | 1200 | WINDOW SHUTTER |
| D10 | 600 | 1200 | WINDOW SHUTTER |
| D11 | 1000 | 600 | VENTILATOR TYPE |
| D12 | 750 | 2400 | STAIR ROOMS WINDOW |
| D13 | 750 | 2400 | FULL GLASS WINDOW |
| D14 | TO SIT AT SITE | | |

SIGNATURE OF THE OWNERS / DEVELOPERS
 N. Moh. Aslam
 Sayed Kamal
 Sayed Kamal
 Sayed Kamal

SIGNATURE OF ENGINEER / ARCHITECT
 Sankar Das
 Sankar Das
 Sankar Das

GAO TECH
 7/7, GAO TECH, CHINSURAH, HOOGHLY, WEST BENGAL, INDIA.
 CONTACT: 98302 22222, 98302 22222
 WEBSITE: www.gaotech.com

PROJECT TITLE: DRAWN BY - SANDIP DAS
 CHECKED BY - SANDIP DAS
 SCALE USED: 1:100, 1:50, 1:25
 NORTH LINE: N

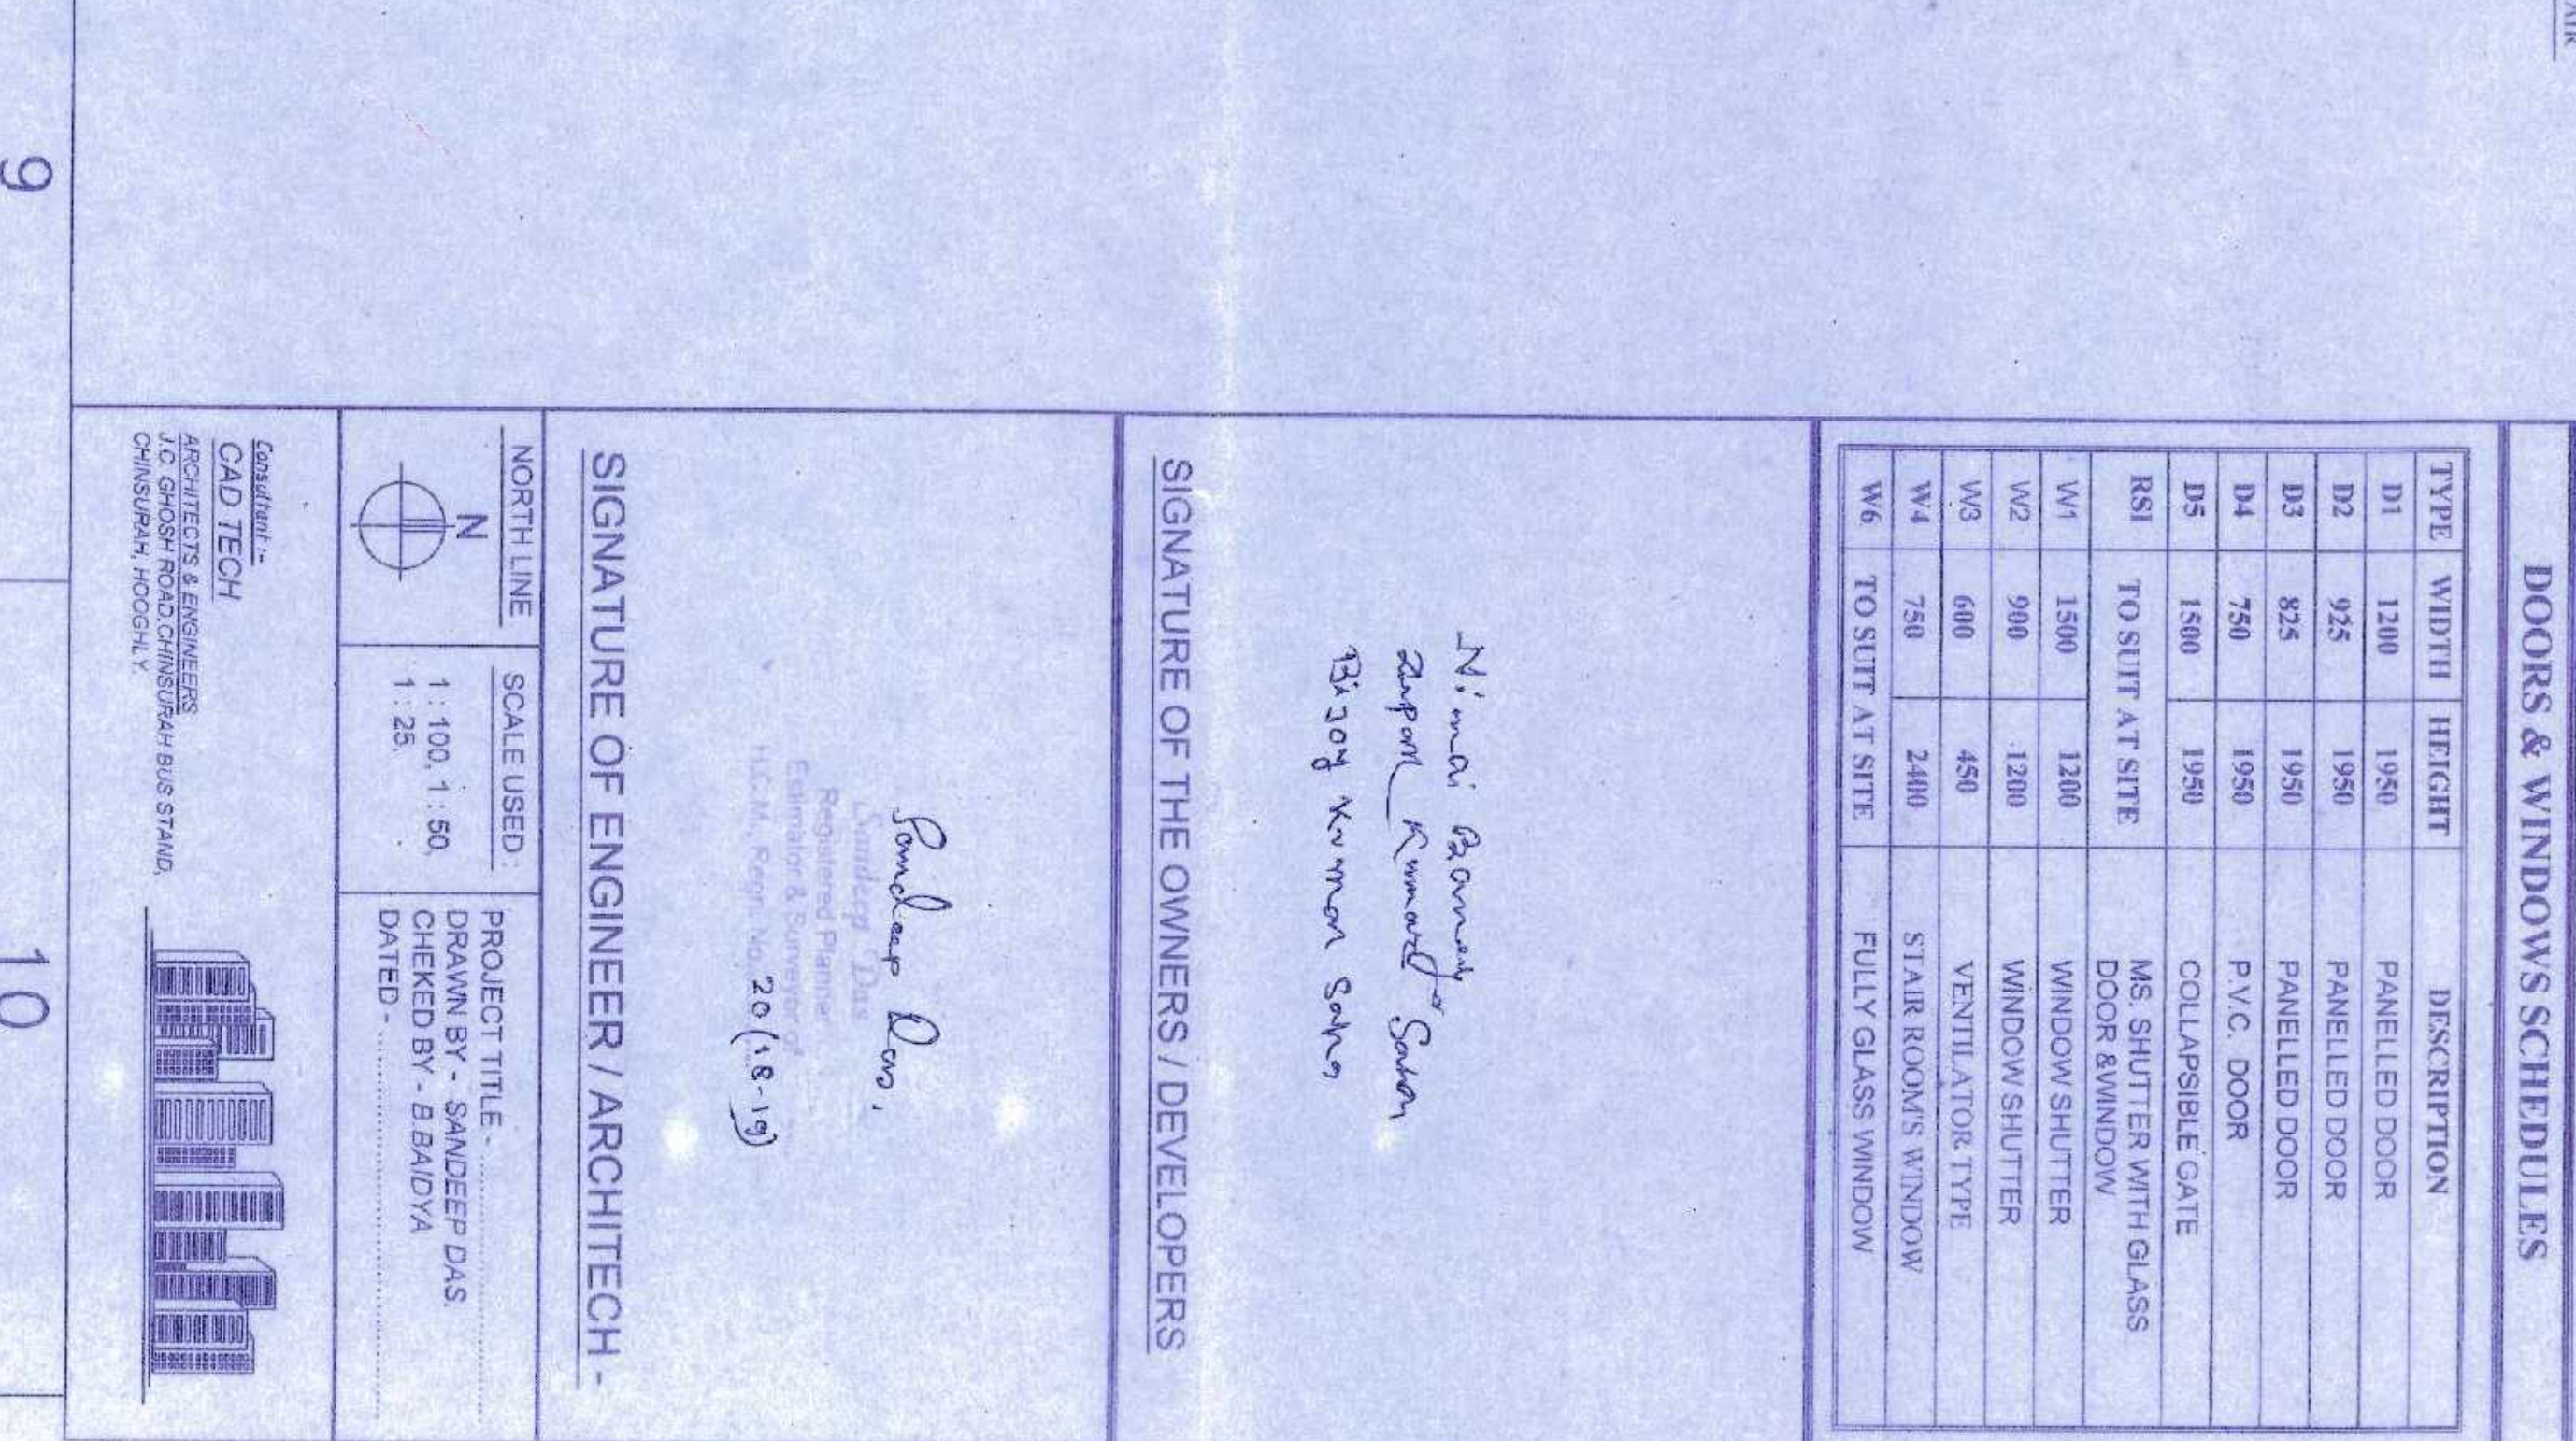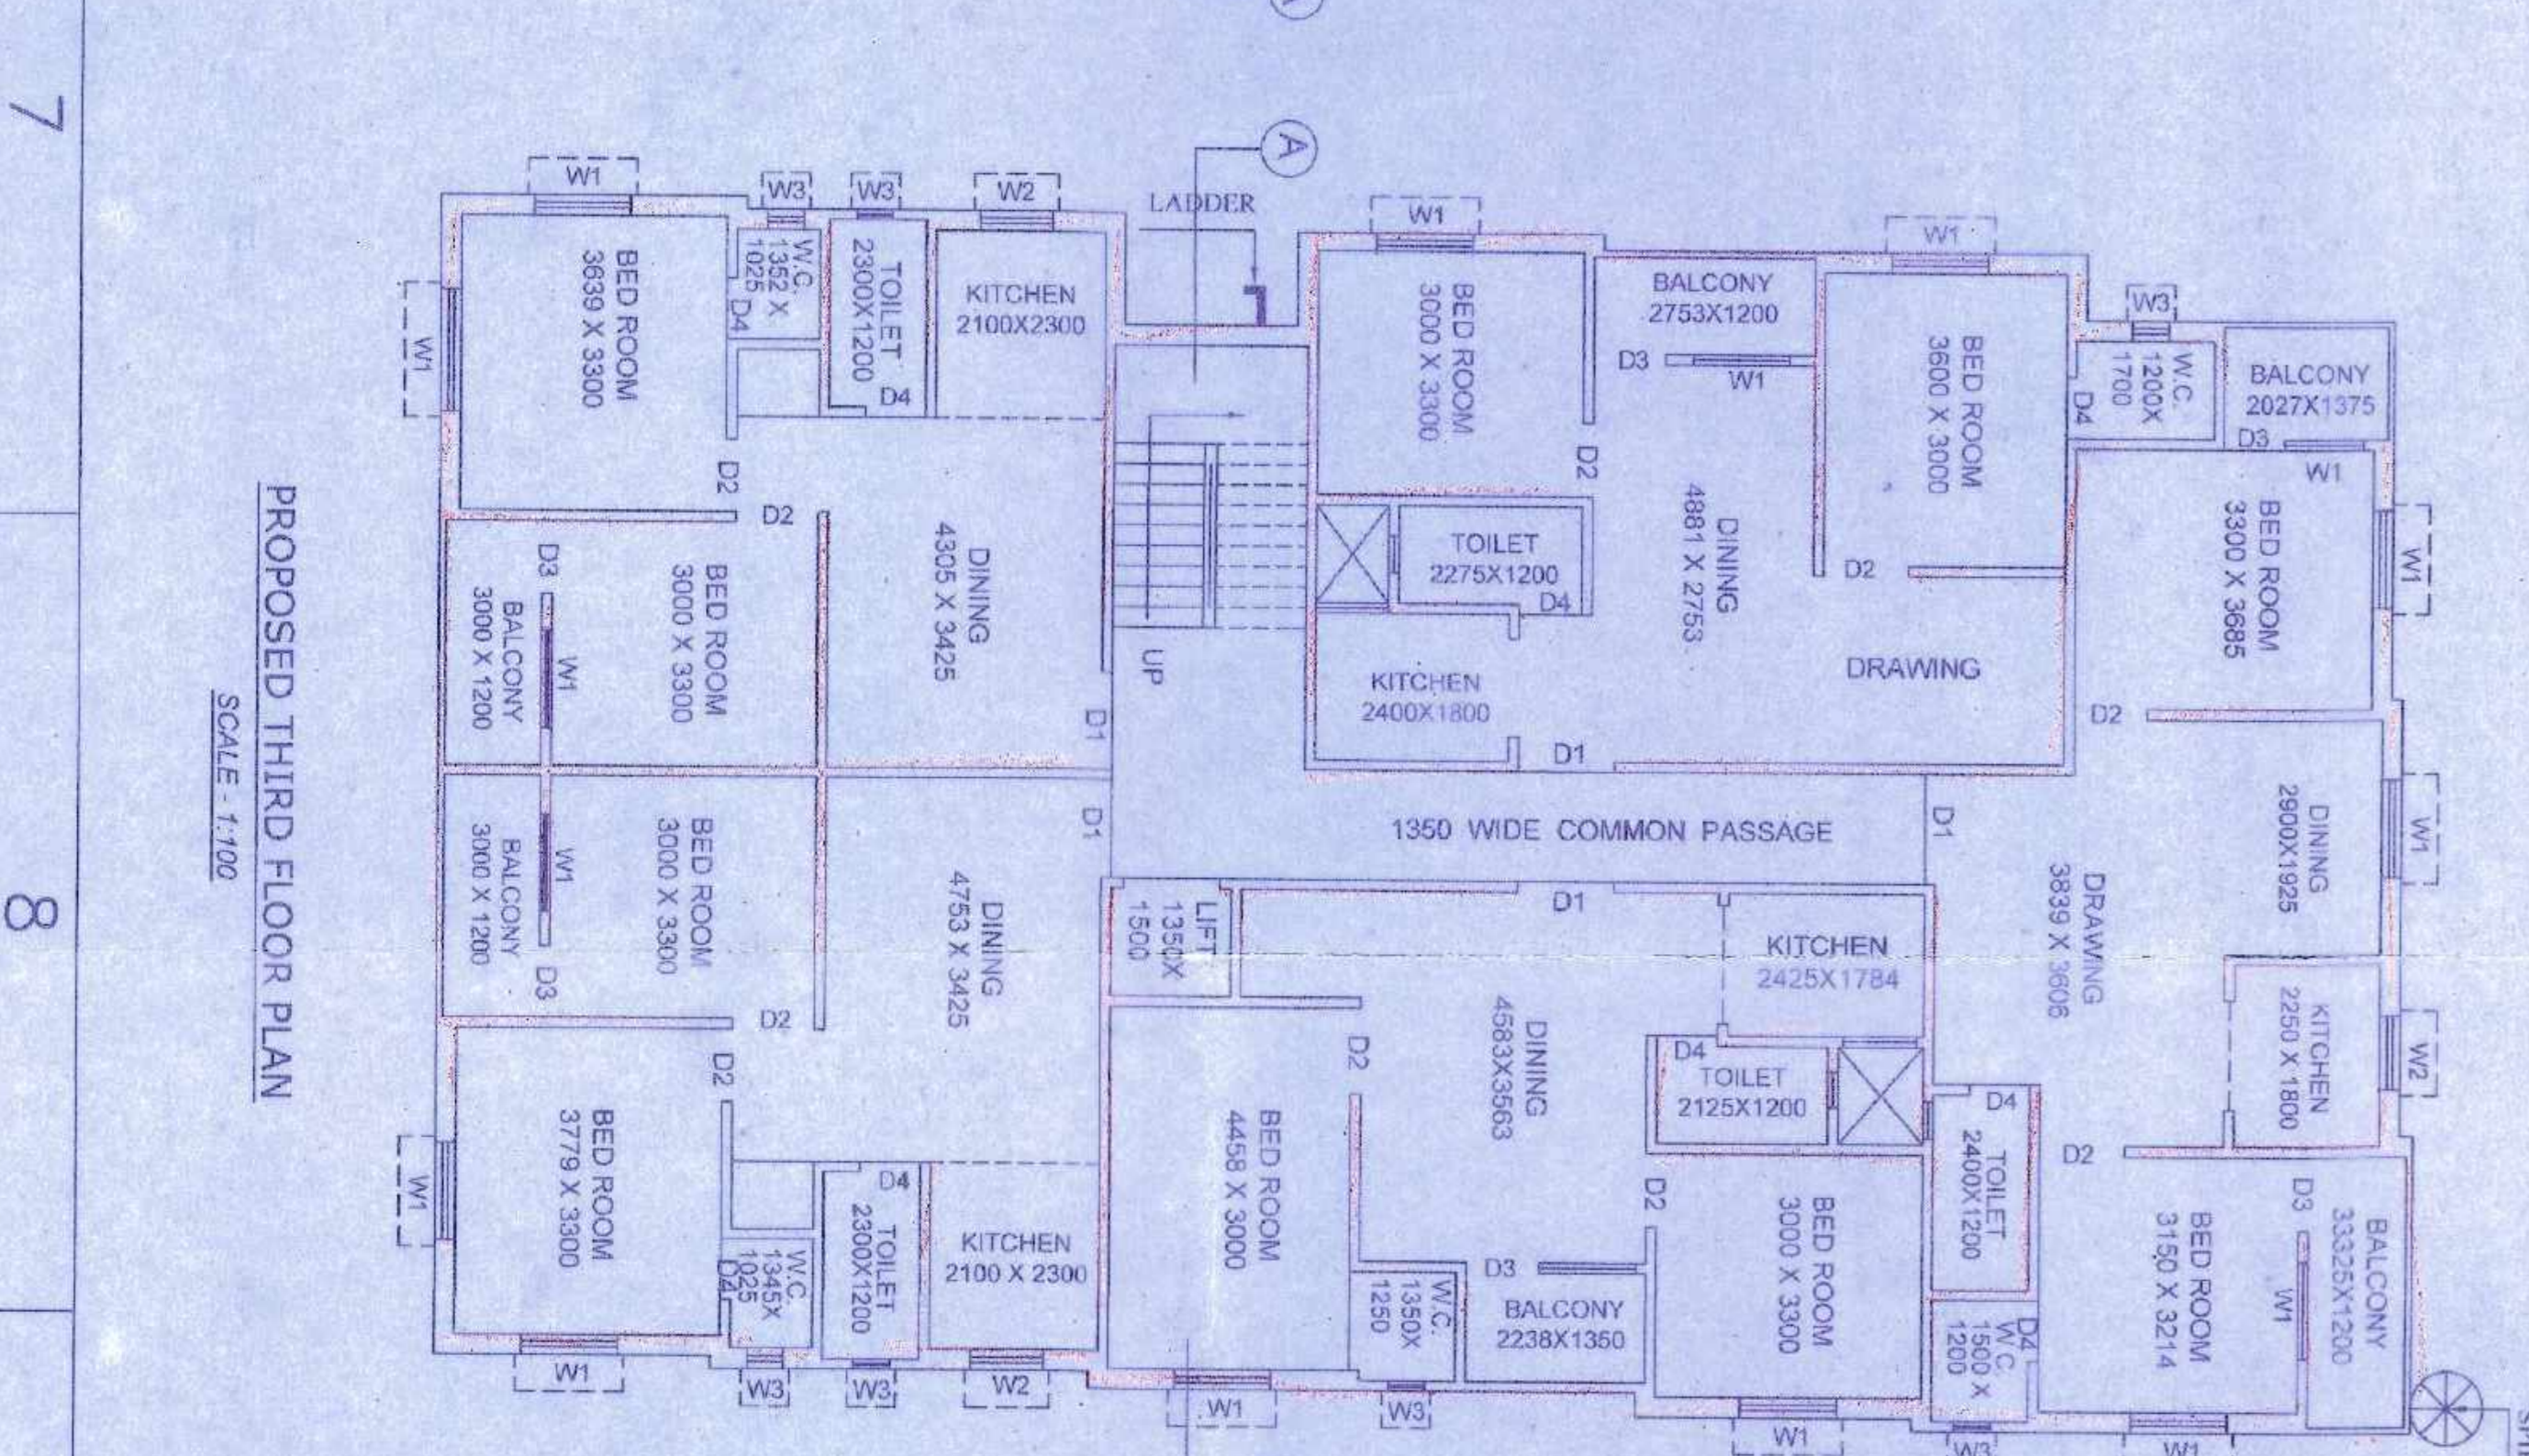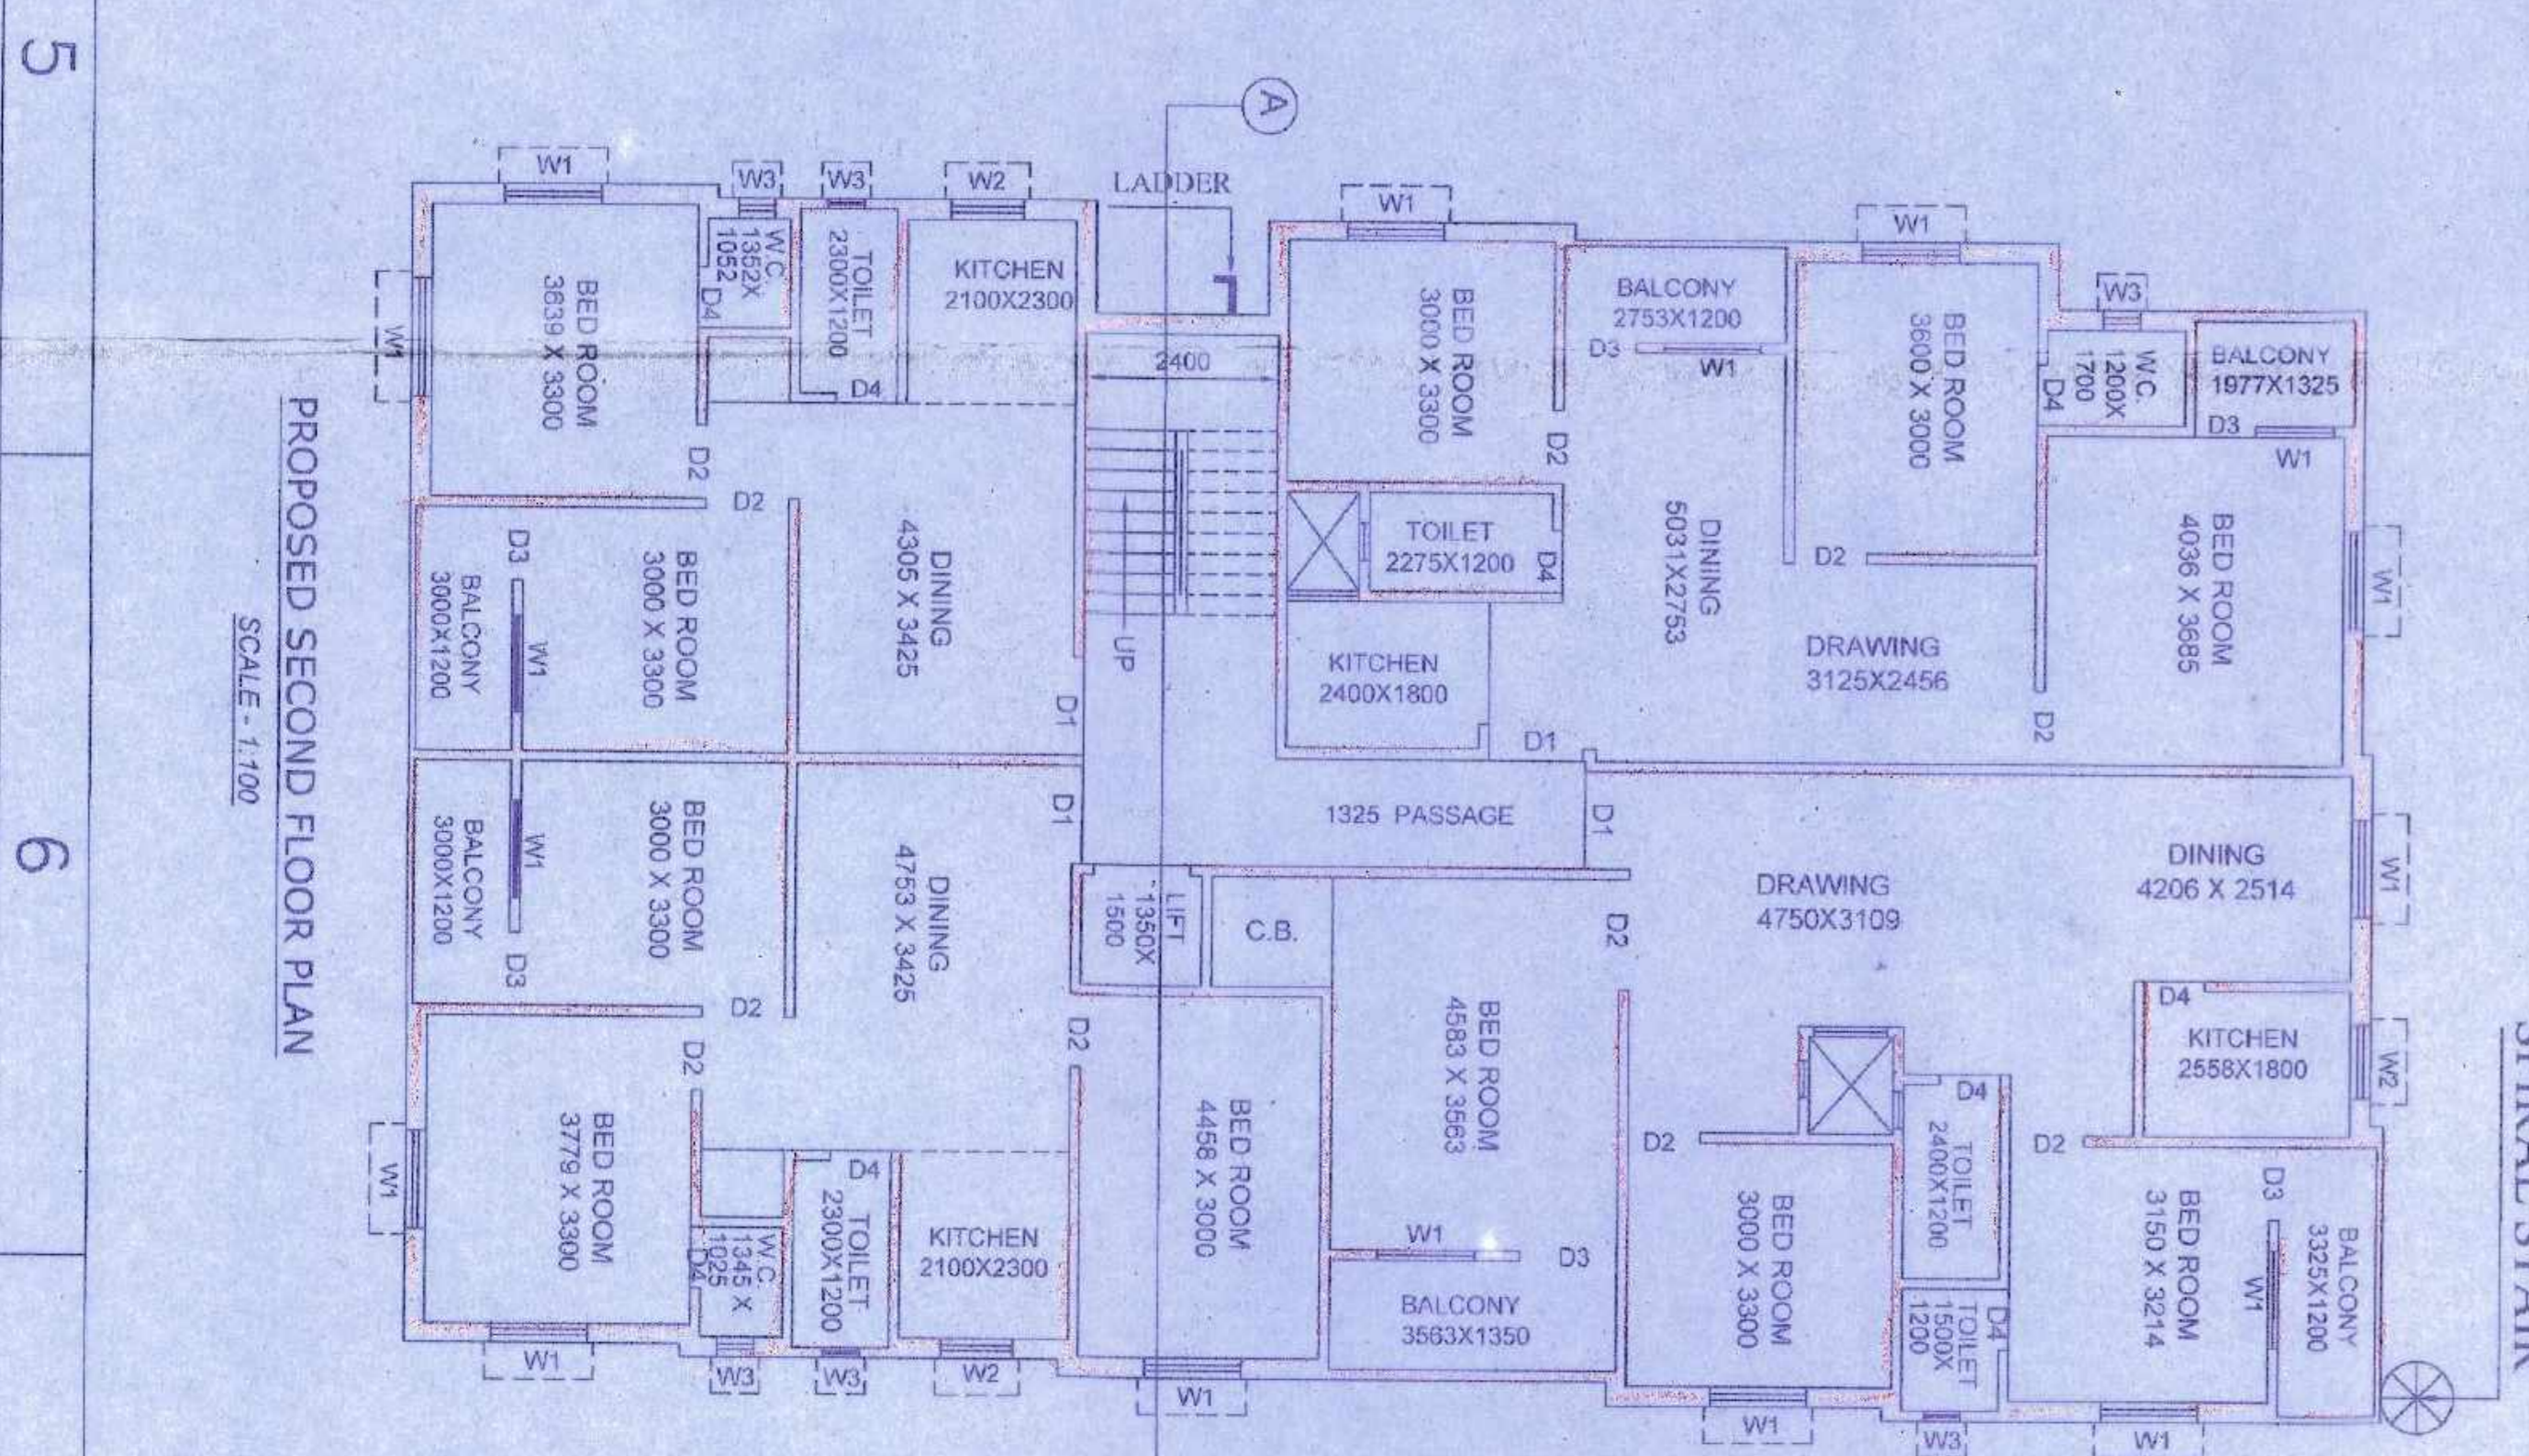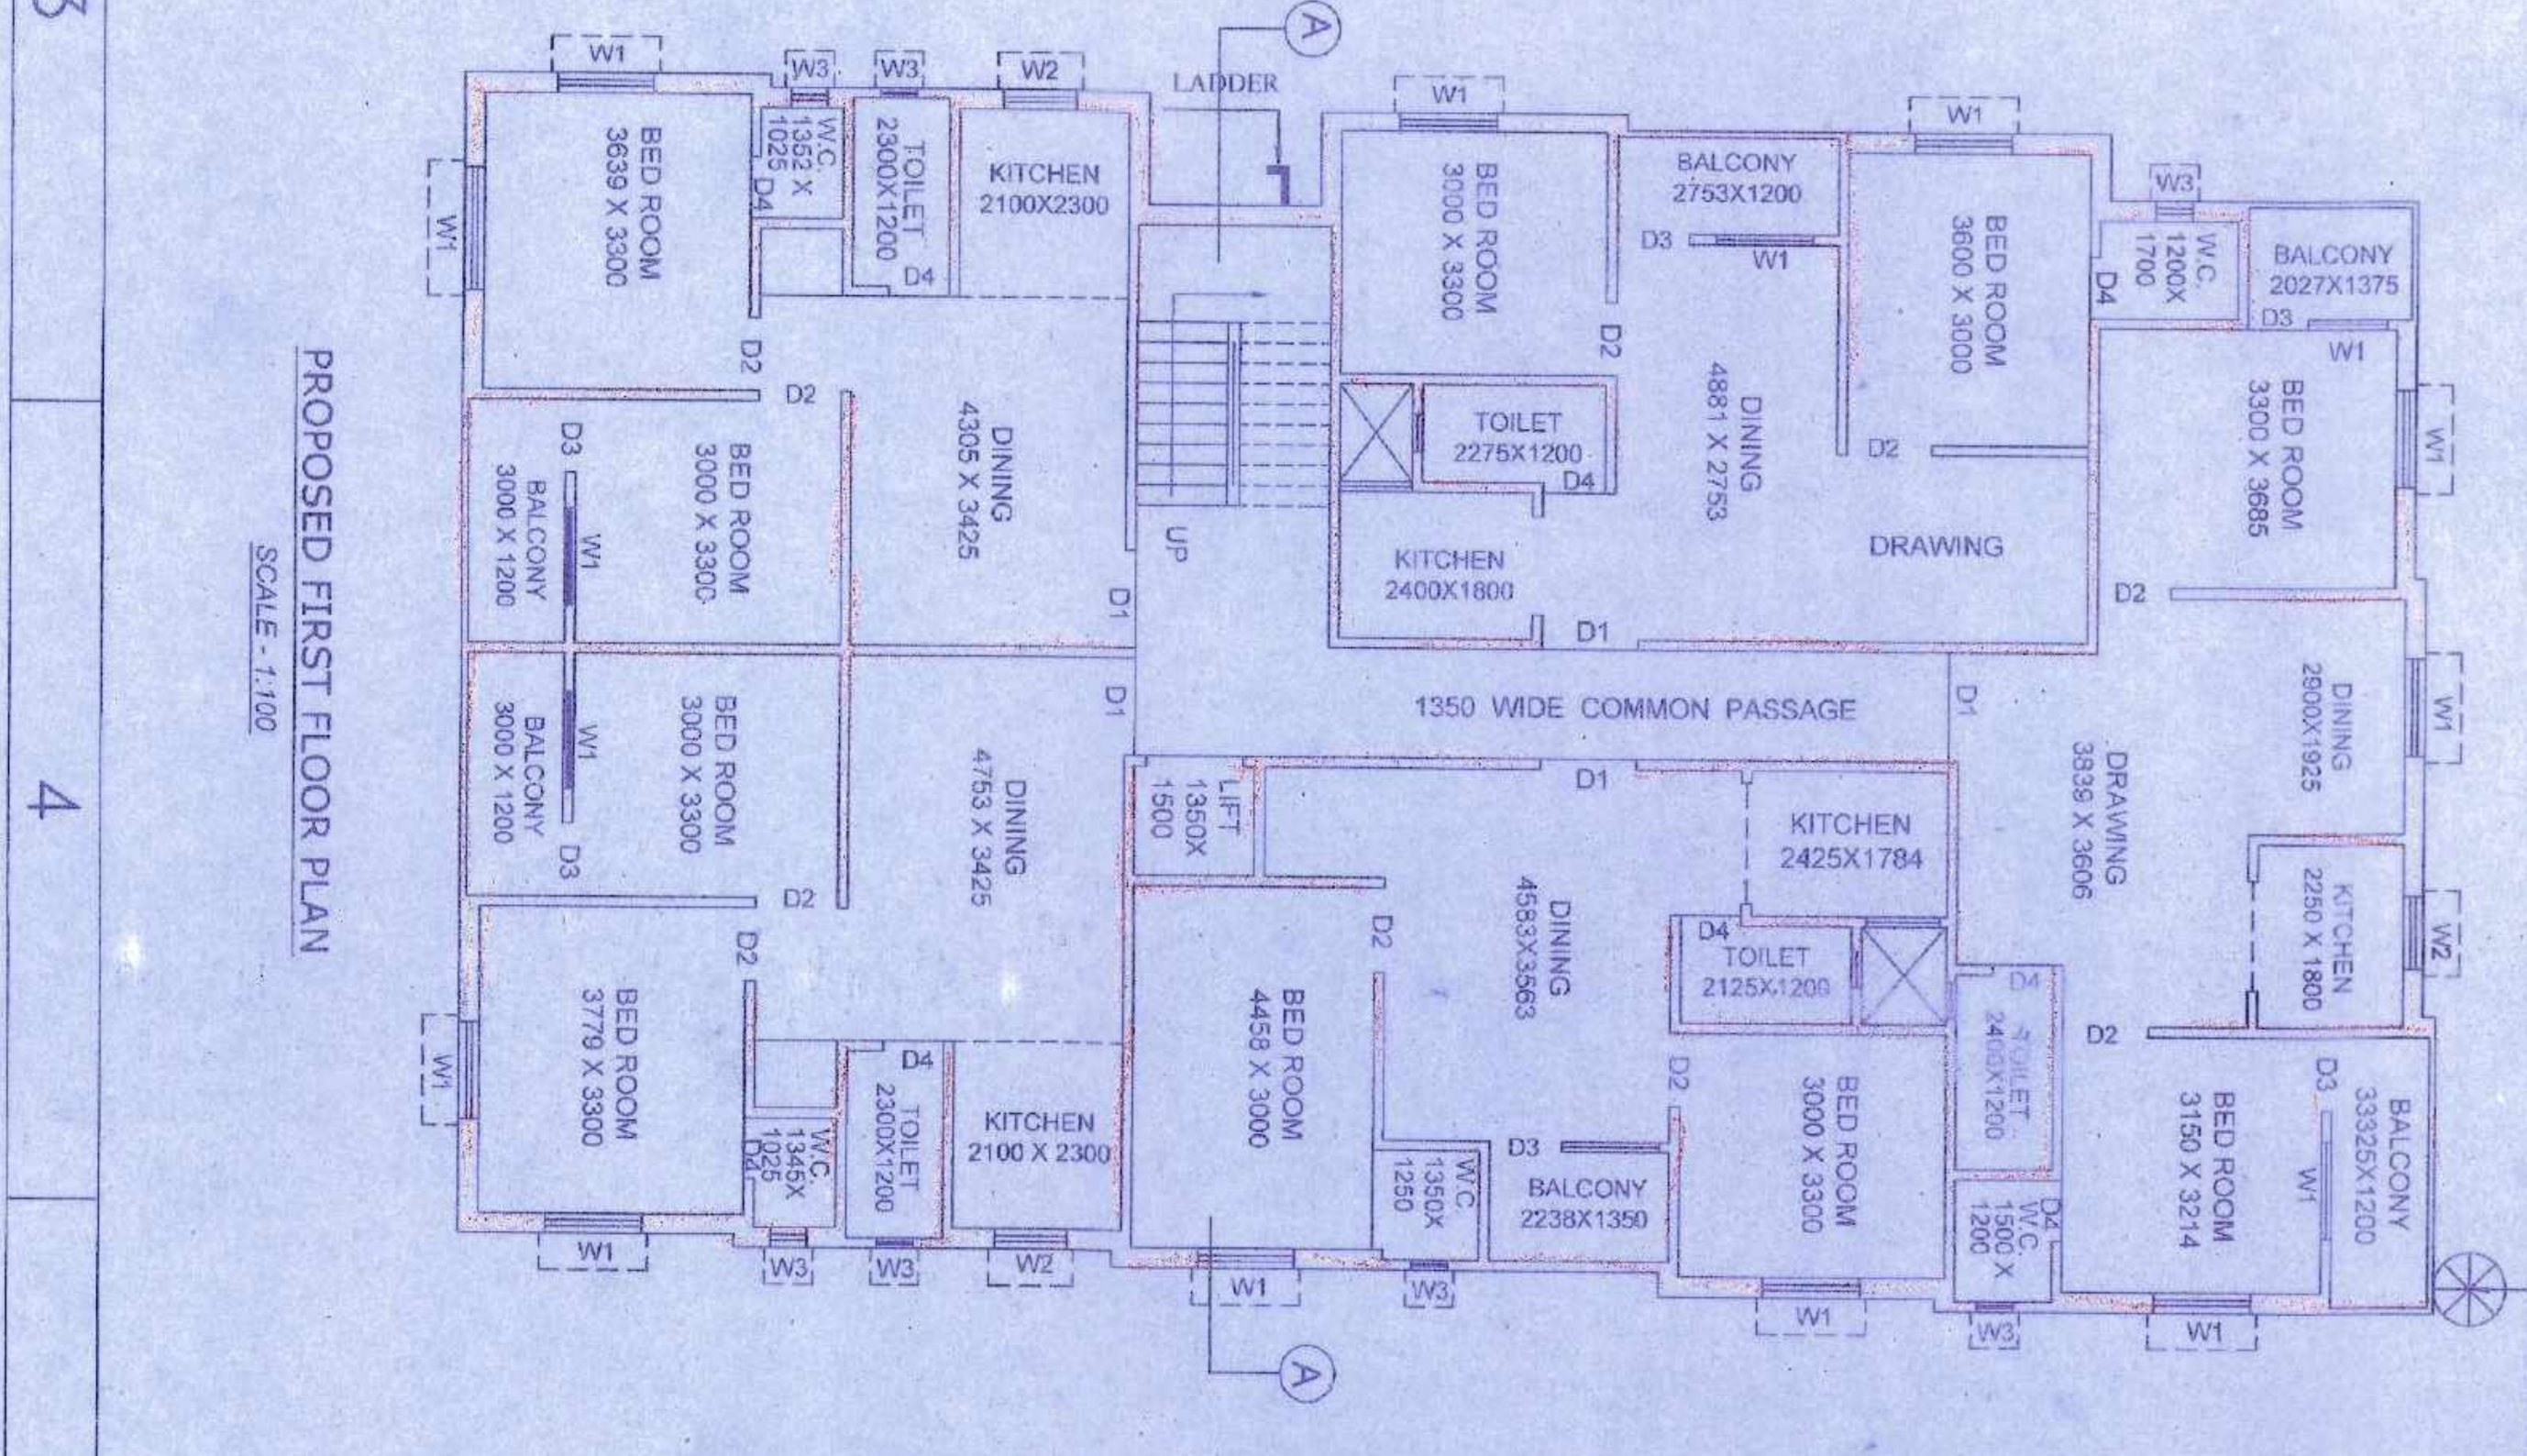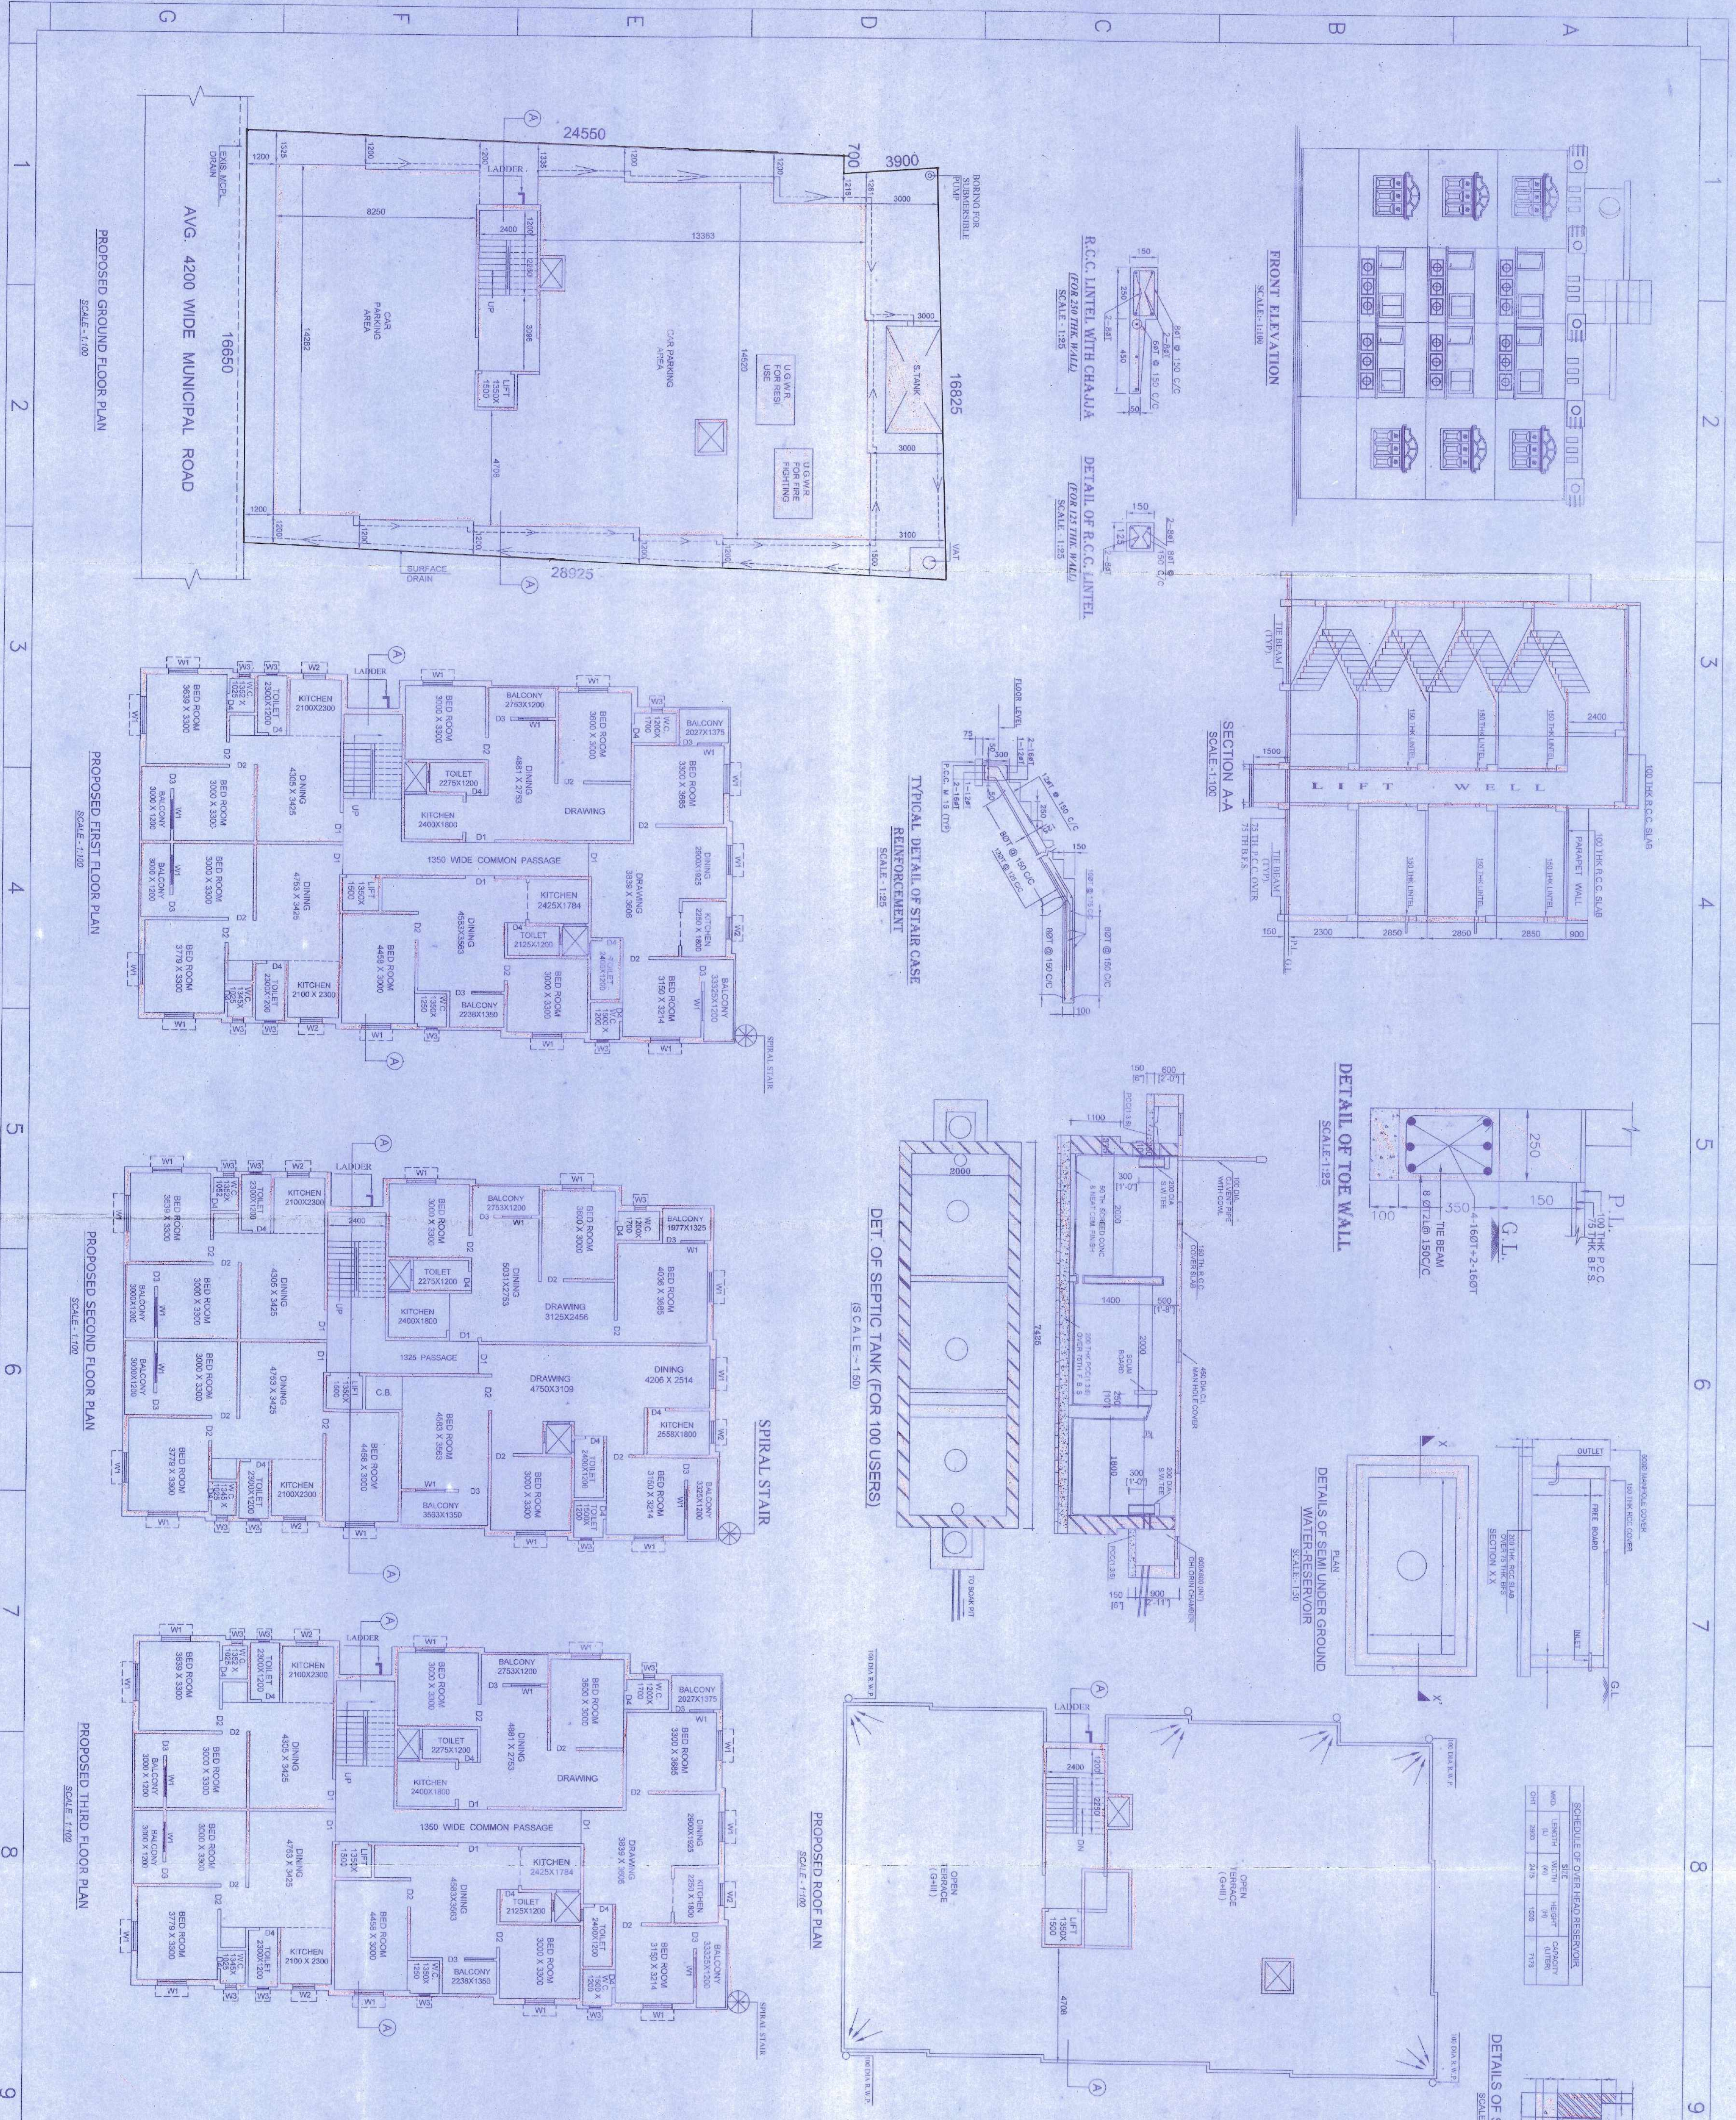

AVG. 4200 WIDE MUNICIPAL ROAD
SCALE: 1:100

PROPOSED GROUND FLOOR PLAN
SCALE: 1:100

PROPOSED FIRST FLOOR PLAN
SCALE: 1:100

PROPOSED SECOND FLOOR PLAN
SCALE: 1:100

PROPOSED THIRD FLOOR PLAN
SCALE: 1:100

PROPOSED ROOF PLAN
SCALE: 1:100

Please Note :
1) Sanction valid upto three years.
2) Completion of work within validity may be extended by another period on previously sanctioned plan. Application for renewal shall be made before the expiry of the period of validity.

1) No projection is allowed on the Municipal Land.
2) To provide rain water drain pipes.

Period of building plans to report to the Municipality seven days before starting of construction.

Within a month from completion of the work, the contractor shall be reported to the Municipality.

[Signature]
See
Municipality

SSA/2019/19
[Signature]
Municipality

