

- GENERAL NOTES:**
1. ALL DIMENSIONS ARE IN MILLIMETRES UNLESS OTHERWISE STATED.
  2. ALL EXTERNAL WALLS ARE 200 P.H. ALL INTERNAL WALLS ARE 150 P.H. & 100 P.H.
  3. THE DEPTH OF S.L.G.W.R. & S.P SHALL NEVER EXCEED THE DEPTH OF FOUNDATION.
  4. BRICK WORK 200 P.H. MORTAR 1:4 & BRICK WORK 150 P.H. & 100 P.H. MORTAR 1:4
  5. ALL R.C.C. WORKS AND EXCEPT FOUNDATION MGS.
  6. GRADE OF STEEL FE 415 I.S. CODE 1786-1779.
  7. ALL SHORTS OF PRECAUTIONARY MEASURE WILL BE TAKEN AT THE TIME OF CONSTRUCTION.
  8. OTHERS ITEM ARE AS PER I.S. SPECIFICATION.

**PROPOSED AREA STATEMENT :**

AREA DETAILS :				
BLOCK	NO. OF FLOORS	FLOOR	FLOOR AREA	TOTAL FLOOR AREA
08K	1	GROUND FLOOR	264.79 SQM	264.79 SQM
		TYPICAL FLOOR	264.79 SQM	
		TOTAL FLOOR AREA	264.79 + (264.79 X 1) = 529.58 SQM	
08K-1	1	GROUND FLOOR	307.33 SQM	307.33 SQM
		TYPICAL FLOOR	307.33 SQM	
		TOTAL FLOOR AREA	307.33 + (307.33 X 1) = 614.66 SQM	
08K-1 (TYPE 1)	4	GROUND FLOOR	475.03 SQM	1900.12 SQM
		TYPICAL FLOOR	475.03 SQM	
		TOTAL FLOOR AREA	475.03 + (475.03 X 3) = 1900.12 SQM	
08K-1 (TYPE 2)	4	GROUND FLOOR	475.03 SQM	1900.12 SQM
		TYPICAL FLOOR	475.03 SQM	
		TOTAL FLOOR AREA	475.03 + (475.03 X 3) = 1900.12 SQM	
08K-1 (TYPE 3)	4	GROUND FLOOR	475.03 SQM	1900.12 SQM
		TYPICAL FLOOR	475.03 SQM	
		TOTAL FLOOR AREA	475.03 + (475.03 X 3) = 1900.12 SQM	
08K-1 (TYPE 4)	4	GROUND FLOOR	475.03 SQM	1900.12 SQM
		TYPICAL FLOOR	475.03 SQM	
		TOTAL FLOOR AREA	475.03 + (475.03 X 3) = 1900.12 SQM	
08K-1 (TYPE 5)	4	GROUND FLOOR	475.03 SQM	1900.12 SQM
		TYPICAL FLOOR	475.03 SQM	
		TOTAL FLOOR AREA	475.03 + (475.03 X 3) = 1900.12 SQM	
08K-1 (TYPE 6)	4	GROUND FLOOR	475.03 SQM	1900.12 SQM
		TYPICAL FLOOR	475.03 SQM	
		TOTAL FLOOR AREA	475.03 + (475.03 X 3) = 1900.12 SQM	
08K-1 (TYPE 7)	4	GROUND FLOOR	475.03 SQM	1900.12 SQM
		TYPICAL FLOOR	475.03 SQM	
		TOTAL FLOOR AREA	475.03 + (475.03 X 3) = 1900.12 SQM	
08K-1 (TYPE 8)	4	GROUND FLOOR	475.03 SQM	1900.12 SQM
		TYPICAL FLOOR	475.03 SQM	
		TOTAL FLOOR AREA	475.03 + (475.03 X 3) = 1900.12 SQM	
TOTAL	15		4132.09 SQM	1760.79 SQM

**PROPOSED GROUND COVERAGE :**

BLOCK	NO. OF FLOORS	GROUND COVERAGE (SQM)	LAND AREA	ROAD WIDTH
08K	1	264.79 SQM	11304.82 SQM	6.5 M
08K-1	1	307.33 SQM	476	4.5 M
08K-1 (TYPE 1)	4	1900.12 SQM	427.192 SQM	
08K-1 (TYPE 2)	4	1900.12 SQM	427.192 SQM	
08K-1 (TYPE 3)	4	1900.12 SQM	427.192 SQM	
08K-1 (TYPE 4)	4	1900.12 SQM	427.192 SQM	
08K-1 (TYPE 5)	4	1900.12 SQM	427.192 SQM	
08K-1 (TYPE 6)	4	1900.12 SQM	427.192 SQM	
08K-1 (TYPE 7)	4	1900.12 SQM	427.192 SQM	
08K-1 (TYPE 8)	4	1900.12 SQM	427.192 SQM	
TOTAL	15	4132.09 SQM	1760.79 SQM	

TOTAL NO. OF CAR/TWO WHEELER PARKING PROVIDED : 175  
 NO. OF COVERED CAR PARKING : 79  
 NO. OF OPEN CAR PARKING : 113  
 NO. OF OPEN TWO WHEELER PARKING : 56

**SANCTIONED AREA STATEMENT :**

AREA DETAILS :				
BLOCK	NO. OF FLOORS	FLOOR	FLOOR AREA	TOTAL FLOOR AREA
08K	1	GROUND FLOOR	216.36 SQM	216.36 SQM
		TYPICAL FLOOR	216.36 SQM	
		TOTAL FLOOR AREA	216.36 + (216.36 X 1) = 432.72 SQM	
08K-1	1	GROUND FLOOR	187.73 SQM	187.73 SQM
		TYPICAL FLOOR	187.73 SQM	
		TOTAL FLOOR AREA	187.73 + (187.73 X 1) = 375.46 SQM	
08K-1 (TYPE 1)	4	GROUND FLOOR	428.83 SQM	1715.32 SQM
		TYPICAL FLOOR	428.83 SQM	
		TOTAL FLOOR AREA	428.83 + (428.83 X 3) = 1715.32 SQM	
08K-1 (TYPE 2)	4	GROUND FLOOR	428.83 SQM	1715.32 SQM
		TYPICAL FLOOR	428.83 SQM	
		TOTAL FLOOR AREA	428.83 + (428.83 X 3) = 1715.32 SQM	
08K-1 (TYPE 3)	4	GROUND FLOOR	428.83 SQM	1715.32 SQM
		TYPICAL FLOOR	428.83 SQM	
		TOTAL FLOOR AREA	428.83 + (428.83 X 3) = 1715.32 SQM	
08K-1 (TYPE 4)	4	GROUND FLOOR	428.83 SQM	1715.32 SQM
		TYPICAL FLOOR	428.83 SQM	
		TOTAL FLOOR AREA	428.83 + (428.83 X 3) = 1715.32 SQM	
08K-1 (TYPE 5)	4	GROUND FLOOR	428.83 SQM	1715.32 SQM
		TYPICAL FLOOR	428.83 SQM	
		TOTAL FLOOR AREA	428.83 + (428.83 X 3) = 1715.32 SQM	
08K-1 (TYPE 6)	4	GROUND FLOOR	428.83 SQM	1715.32 SQM
		TYPICAL FLOOR	428.83 SQM	
		TOTAL FLOOR AREA	428.83 + (428.83 X 3) = 1715.32 SQM	
08K-1 (TYPE 7)	4	GROUND FLOOR	428.83 SQM	1715.32 SQM
		TYPICAL FLOOR	428.83 SQM	
		TOTAL FLOOR AREA	428.83 + (428.83 X 3) = 1715.32 SQM	
08K-1 (TYPE 8)	4	GROUND FLOOR	428.83 SQM	1715.32 SQM
		TYPICAL FLOOR	428.83 SQM	
		TOTAL FLOOR AREA	428.83 + (428.83 X 3) = 1715.32 SQM	
TOTAL	15		1760.79 SQM	1760.79 SQM

**PROPOSED GROUND COVERAGE :**

BLOCK	NO. OF FLOORS	GROUND COVERAGE (SQM)	LAND AREA	ROAD WIDTH
08K	1	216.36 SQM	11304.82 SQM	6.5 M
08K-1	1	187.73 SQM	476	4.5 M
08K-1 (TYPE 1)	4	1715.32 SQM	427.192 SQM	
08K-1 (TYPE 2)	4	1715.32 SQM	427.192 SQM	
08K-1 (TYPE 3)	4	1715.32 SQM	427.192 SQM	
08K-1 (TYPE 4)	4	1715.32 SQM	427.192 SQM	
08K-1 (TYPE 5)	4	1715.32 SQM	427.192 SQM	
08K-1 (TYPE 6)	4	1715.32 SQM	427.192 SQM	
08K-1 (TYPE 7)	4	1715.32 SQM	427.192 SQM	
08K-1 (TYPE 8)	4	1715.32 SQM	427.192 SQM	
TOTAL	15	1760.79 SQM	1760.79 SQM	

TOTAL NO. OF CAR/TWO WHEELER PARKING PROVIDED : 319  
 NO. OF COVERED CAR PARKING : 41  
 NO. OF OPEN CAR/TWO WHEELER PARKING : 276  
 NO. OF OPEN TWO WHEELER PARKING : 233

**PROJECT TITLE:**

PROPOSED G+4 STORED HOUSING COMPLEX AT MOUZA - AMTALA, P.S. BISHNUPUR, J.L. NO. - 73, RS DAG NO. 978, 979, 981, 982 & 985 & LR DAG NO. 1831, 1832, 1837, 1839 & 1836, KHATIAN NO.823, BLOCK - BISHNUPUR-2, GRAM PANCHAYAT - CHANDI, DISTRICT - SOUTH 24 PARGANAS

**SHEET TITLE:**

MASTER PLAN SHOWING GROUND FLOOR, SITE PLAN & LOCATION PLAN

**ARCHITECT**

**Subir Kumar Basu**  
 CONSULTING ARCHITECTS & ENGINEERS  
 4, BROAD STREET  
 KOLKATA-700019

DRAWN BY: MADHURITA	DEALT BY: INDRAJ	CHECKED BY: RAJA BASU
SCALE: 1:200	SHEET NO. - 1 OF 8	DATE: 10/11/2017
DRAWING NO. - SKB/AMTALAAR/SANC/MASTER PLAN/01		

THE STRUCTURAL DESIGN AND DRAWINGS OF BOTH FOUNDATION & SUPERSTRUCTURE OF THE BUILDING HAS BEEN MADE BY ME CONSIDERING ALL POSSIBLE LOADS INCLUDING THE SEISMIC LOAD AS PER THE NATIONAL BUILDING CODE OF INDIA & CERTIFIED THAT IT IS SAFE & STABLE IN ALL RESPECTS

*SAVITA J. PARIKH*  
 REGISTERED CIVIL ENGINEER  
 R.E.C. NO. IN R.C. 104

SIGN OF STRUCTURAL ENGINEER

*Subir Kumar Basu*  
 REGISTERED ARCHITECT  
 R.A. NO. IN R.A. 104

SIGN OF ARCHITECT

OWNER: *Subir Kumar Basu*

SIGN OF OWNER

- 1. All work shall be executed in accordance with the specifications mentioned in the contract documents.
- 2. The contractor shall be responsible for the safety of the workmen and the public.
- 3. The contractor shall be responsible for the safety of the workmen and the public.
- 4. The contractor shall be responsible for the safety of the workmen and the public.
- 5. The contractor shall be responsible for the safety of the workmen and the public.
- 6. The contractor shall be responsible for the safety of the workmen and the public.
- 7. The contractor shall be responsible for the safety of the workmen and the public.
- 8. The contractor shall be responsible for the safety of the workmen and the public.
- 9. The contractor shall be responsible for the safety of the workmen and the public.
- 10. The contractor shall be responsible for the safety of the workmen and the public.

**MASTER PLAN SHOWING GROUND FLOOR PLANS**



















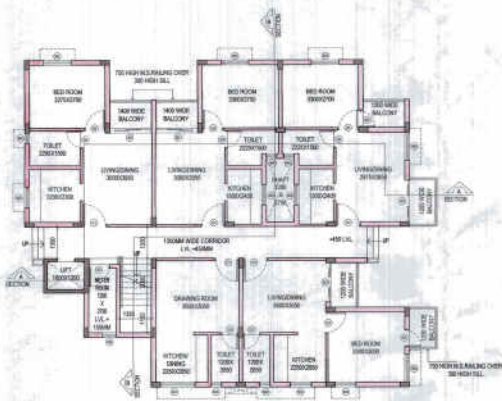


GROUND FLOOR PLAN




TYPICAL FLOOR PLAN

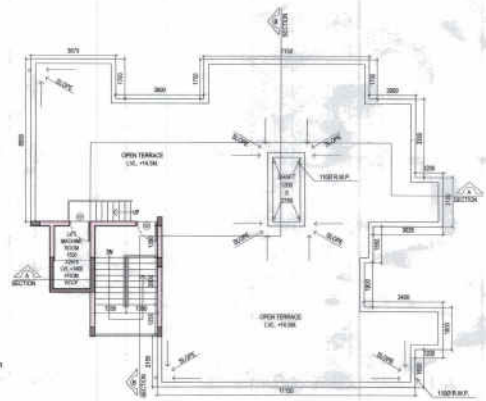


ROOF PLAN

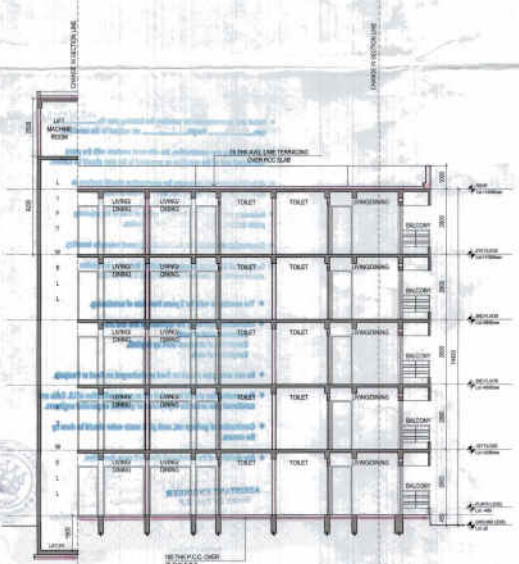

SECTION 'A'

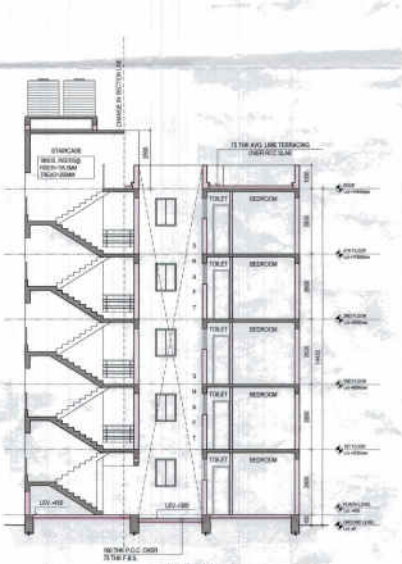

SECTION 'B'

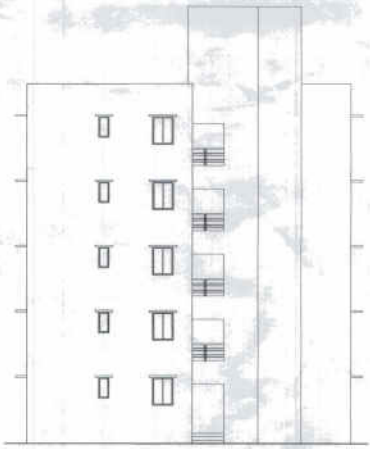

FRONT ELEVATION

**SPECIFICATIONS:-**

- ALL DIMENSIONS ARE IN MILLIMETERS UNLESS OTHERWISE STATED
- ALL EXTERNAL WALLS ARE 200 & ALL INTERNAL WALLS ARE 100 & 75MM
- THE DEPTH OF G.O.W.R. SHALL NEVER EXCEED THE DEPTH OF FOUNDATION
- BRICK WORK 200 & MORTAR 1:4 & BRICK WORK 100 & 75MM WORK 1:4
- ALL SHORTS OF PRECAUTIONARY MEASURE WILL BE TAKEN AT THE TIME OF CONSTRUCTION
- OTHERS ITEM ARE AS PER I.S. SPECIFICATION

THE STRUCTURAL DESIGN & DRAWING OF BOTH FOUNDATION & SUPERSTRUCTURE OF THE BUILDING HAS BEEN MADE BY ME CONSIDERING ALL POSSIBLE LOADS INCLUDING THE SEISMIC LOAD AS PER THE NATIONAL BUILDING CODE OF INDIA & CERTIFIED THAT IT IS SAFE & STABLE IN ALL RESPECT.

*Sanjay B. Pareki*

SANJAY B. PAREKI  
M.E. STRUCTURAL ENGINEER  
R. C. E., REG. OF ARCHT. &  
E. S. E. NO. 10410 & M. C.

SIGN. OF STRUCTURAL ENGINEER.

*Subir Kumar Basu*  
Subir Kumar Basu  
Director

SIGN. OF OWNER.

*Subir Kumar Basu*  
Subir Kumar Basu  
Registered Architect  
Reg. No. - CA704375

SIGN. OF ARCHITECT.

**DOOR / WINDOW OPENING SCHEDULE**

SL. NO.	LEGEND	SIZE	LINTEL HT.	SL. HT.	SPECIFICATIONS
1	D0	-	2100	-	SLEIGH DOOR
2	D1	1050 x 2100	2100	-	FLUSH DOOR
3	D2	900 x 2100	2100	-	FLUSH DOOR
4	D3	750 x 2100	2100	-	FLUSH DOOR
5	W1	1500 x 1400	2400	1000	CASEMENT WINDOW
6	W2	1200 x 1400	2400	1000	CASEMENT WINDOW
7	W3	900 x 1200	2400	1200	CASEMENT WINDOW
8	W4	600 x 900	2400	1500	CASEMENT WINDOW
9	W5	450 x 900	2400	1500	CASEMENT WINDOW

**PROJECT TITLE:-**

PROPOSED G+4 STORED HOUSING COMPLEX AT MOUZA - AMTALA, P.S. BISHNUPUR, J.L. NO. - 73, RS DAG NO. 978, 979, 981, 982 & 985 & LR DAG NO. 1631, 1632, 1637, 1639 & 1636, KHATIAN NO.923, BLOCK - BISHNUPUR-2, GRAM PANCHAYET - CHANDI, DISTRICT - SOUTH 24 PARGANAS.

SHEET TITLE - 1 BHK UNIT

FLOOR PLANS, ROOF PLAN, ELEVATION & SECTIONS

ARCHITECT







**Subir Kumar Basu**  
CONSULTING ARCHITECTS & ENGINEERS  
4, BROAD STREET  
KOLKATA-700019

DRAWN BY: MASHANTI      SEAT BY: NORRI      CHECKED BY: RAJ. BASU  
SCALE: 1:100      SHEET NO.: 8/07E      DATE: - 03.11.2017

DRAWING NO.: SBAMTALAPRASHANT/07E/08





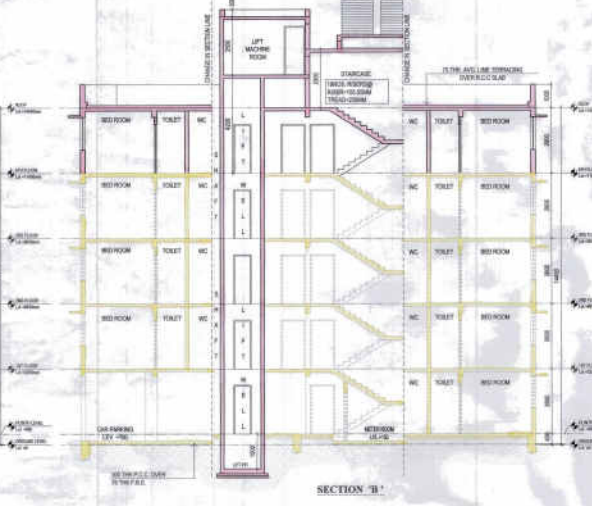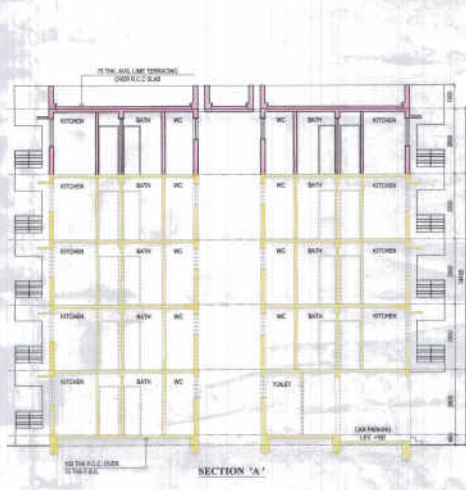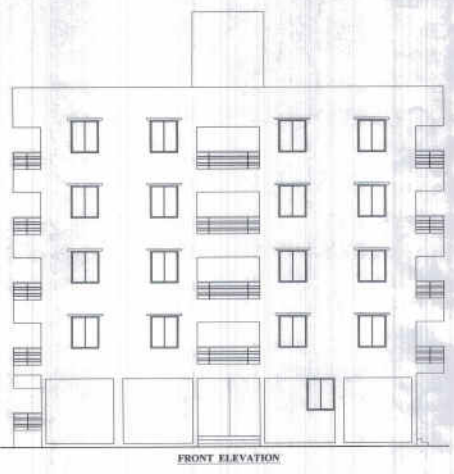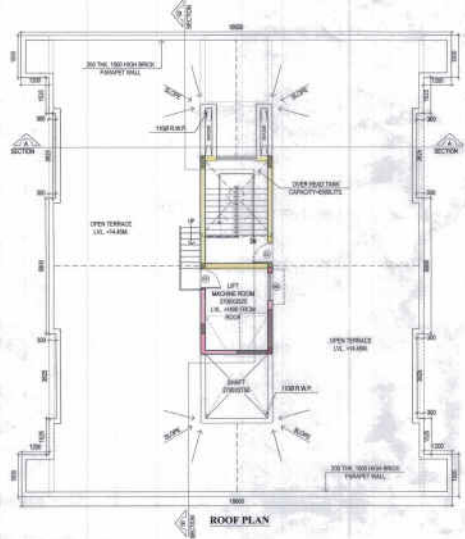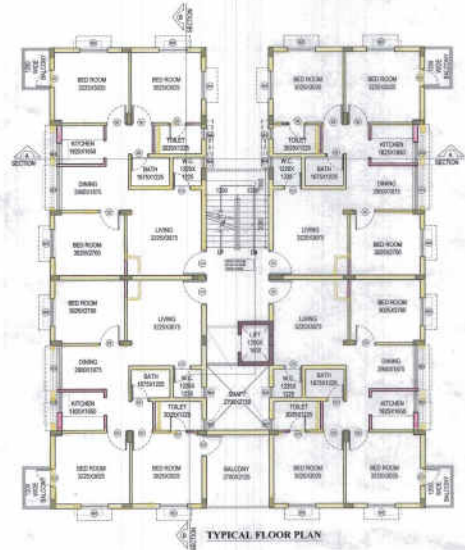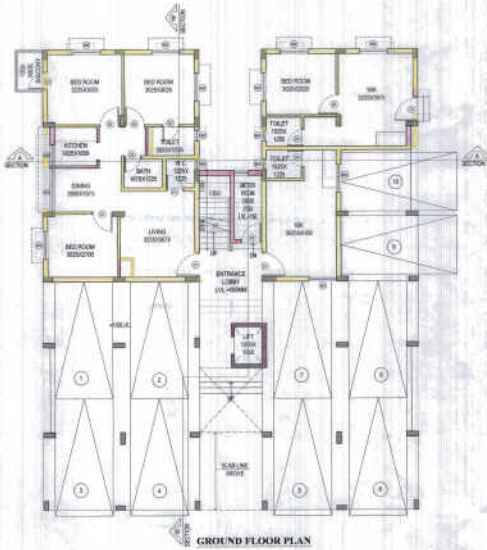

**SPECIFICATIONS:-**

- ALL DIMENSIONS ARE IN MILLIMETERS UNLESS OTHERWISE STATED
- ALL EXTERNAL WALLS ARE 200 B & ALL INTERNAL WALLS ARE BOTH A WITH THE DEPTH OF 400 B.W. SHALL NEVER EXCEED THE DEPTH OF FOUNDATION
- BRICK WORK 200 B.M. MORTAR 1:6 & BRICK WORK 100 B & 750 MORTAR 1:4
- ALL DETAILS OF PRECAUTIONARY MEASURES WILL BE TAKEN AT THE TIME OF CONSTRUCTION
- OTHERS ITEM ARE AS PER I.E. SPECIFICATION.

THE STRUCTURAL DESIGN & DRAWING OF BOTH FOUNDATION & SUPERSTRUCTURE OF THE BUILDING HAS BEEN MADE BY ME CONSIDERING ALL POSSIBLE LOADS INCLUDING THE SEISMIC LOAD AS PER THE NATIONAL BUILDING CODE OF INDIA & CERTIFIED THAT IT IS SAFE & STABLE IN ALL RESPECT.

**SIGN OF STRUCTURAL ENGINEER**

**SANJIV J. PARKER**  
 M.E., M.T.E.C.T., M.B.A., M.B.A.S., M.B.A.S. (C), M.B.A.S. (E), M.B.A.S. (S), M.B.A.S. (T), M.B.A.S. (U), M.B.A.S. (V), M.B.A.S. (W), M.B.A.S. (X), M.B.A.S. (Y), M.B.A.S. (Z)

**SIGN OF OWNER**

*Subir Kumar Basu*  
**SUBIR KUMAR BASU**  
 Registered Architect  
 Regn. No. CA/764373  
**SIGN OF ARCHITECT**

**DOOR / WINDOW OPENING SCHEDULE**

SL. NO.	LEGEND	SIZE	LINTEL HT.	SILL HT.	SPECIFICATIONS
1	D1	80	2100	-	SLIDING DOOR
2	D1	1000 x 1900	2100	-	FLUSH DOOR
3	D2	900 x 1900	2100	-	FLUSH DOOR
4	D3	750 x 1900	2100	-	FLUSH DOOR
5	W1	1675 x 1800	2400	1000	CASEMENT WINDOW
6	W2	1200 x 1400	2400	1000	CASEMENT WINDOW
7	W3	300 x 1200	2400	1200	CASEMENT WINDOW
8	W4	450 x 900	2400	1800	CASEMENT WINDOW

**PROJECT TITLE:-**  
 PROPOSED G+4 STORED HOUSING COMPLEX AT MOUZA - AMTALA, P.S. BISHNUPUR, J.L. NO. - 73, RS DAG NO. 978, 979, 981, 982 & 985 & LR DAG NO. 1831, 1832, 1837, 1839 & 1836, KHATAN NO.923, BLOCK - BISHNUPUR-2, GRAM PANCHAYET - CHANDI, DISTRICT - SOUTH 24 PARGANAS.

**SHEET TITLE:-** 3 BRK UNIT (TYPE 01)

**FLOOR PLANS, ROOF PLAN, ELEVATION & SECTIONS**

**ARCHITECT**

**Subir Kumar Basu**  
 CONSULTING ARCHITECTS & ENGINEERS  
 4, BROAD STREET  
 KOLKATA-700019

DRAWN BY: MADHURITA      CHECKT BY: MADHURITA      CHECKED BY: RAJA BASU  
 SCALE: 1:100      SHEET NO.: 2 OF 3      DATE: 10.11.2019  
 DRAWING NO.: SBK/AMTALA/RS/2019/01/01














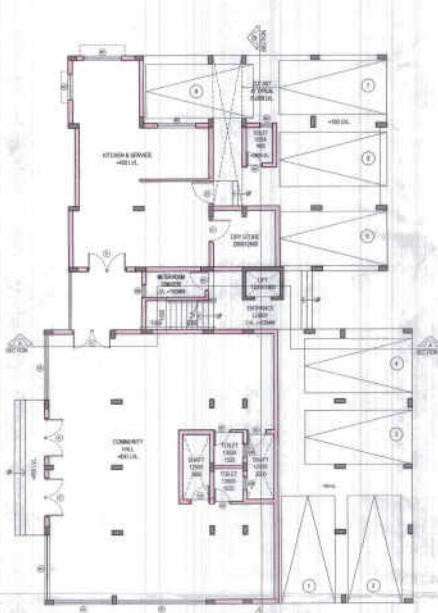

GROUND FLOOR PLAN

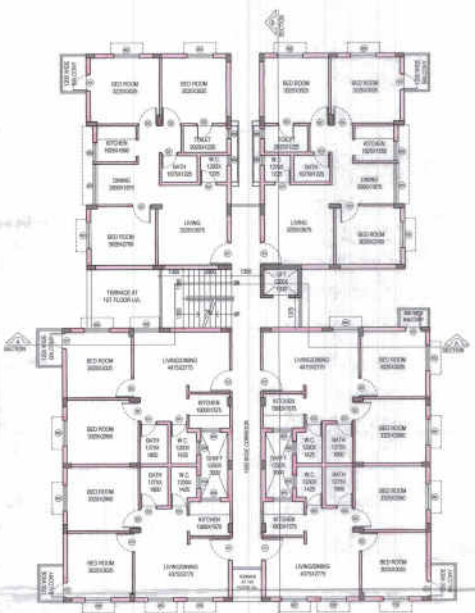


TYPICAL FLOOR PLAN

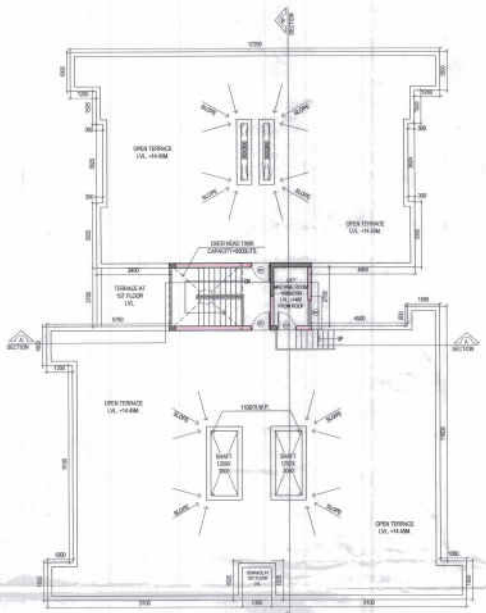

ROOF PLAN



FRONT ELEVATION

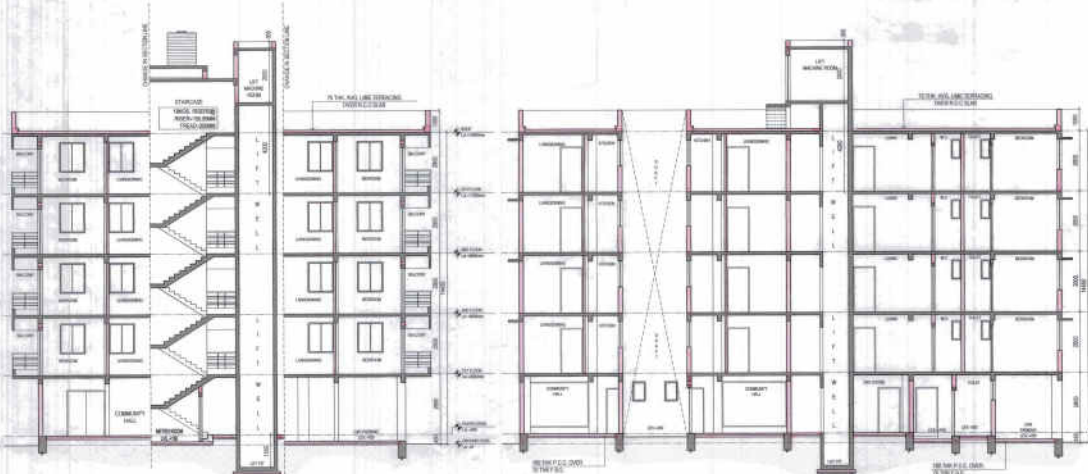

SECTION 'A'

SECTION 'B'

**SPECIFICATIONS:-**

- ALL DIMENSIONS ARE IN MILLIMETERS UNLESS OTHERWISE STATED.
- ALL EXTERNAL WALLS ARE 300 PL & ALL INTERNAL WALLS ARE 100PL & 75PL
- THE DEPTH OF U.O.W.A. SHALL NEVER EXCEED THE DEPTH OF FOUNDATION.
- BRICK WORK 200 PL. MORTAR 1:6 & BRICK WORK 100 PL & 75 PL MORTAR 1:4
- ALL SHORTS OF PRECAUTIONARY MEASURES WILL BE TAKEN AT THE TIME OF CONSTRUCTION.
- OTHERS IS/ARE AS PER I.S. SPECIFICATION.

THE STRUCTURAL DESIGN AND DRAWING OF BOTH FOUNDATION & SUPERSTRUCTURE OF THE BUILDING HAS BEEN MADE BY ME CONSIDERING ALL POSSIBLE LOADS INCLUDING THE SEISMIC LOAD AS PER THE NATIONAL BUILDING CODE OF INDIA & CERTIFIED THAT IT IS SAFE & STABLE IN ALL RESPECT.

*Sanjay Pareek*  
**SANJAY PAREEK**  
 ALL INDIA ENGINEER (CONSULTANT)  
 E.S.E. NO. 284 (D.R. M.C.)

SIGN. OF STRUCTURAL ENGINEER.

*Deekshita Singh*  
**DEEKSHITA SINGH (INDIA) PVT. LTD.**  
 Director

SIGN. OF OWNER.

*Subir Kumar Basu*  
**SUBIR KUMAR BASU**  
 Registered Architect  
 Reg. No. CAT/34173

SIGN. OF ARCHITECT.

**DOOR / WINDOW OPENING SCHEDULE**

SL. NO.	LEGEND	SIZE	LINTEL HT.	HL. HT.	SPECIFICATIONS
1	BD		2100		BUILDING DOOR
2	FD	1850 x 2100	2100		FLUSH DOOR
3	DD	950 x 2100	2100		FLUSH DOOR
4	DD	750 x 2100	2100		FLUSH DOOR
5	W1	1875 x 1600	2400	1000	CASEMENT WINDOW
6	W2	1200 x 1400	2400	1000	CASEMENT WINDOW
7	W3	800 x 1200	2400	1000	CASEMENT WINDOW
8	W4	450 x 800	2400	1000	CASEMENT WINDOW

PROJECT TITLE:-  
 PROPOSED G+4 STORED HOUSING COMPLEX AT MOUZA -  
 AMTALA, P.S. BISHNUPUR, J.L. NO. - 73, RS DAG NO. 978, 979,  
 981, 982 & 985 & LR DAG NO. 1831, 1832, 1837, 1839 & 1836,  
 KHATAN NO.923, BLOCK - BISHNUPUR 2,  
 GRAM PANCHAYET - CHANDI, DISTRICT - SOUTH 24 PARGANAS.

SHEET TITLE:- 2/3 3PK UNIT  
 FLOOR PLANS, ROOF PLAN, ELEVATION & SECTIONS

ARCHITECT  
**Subir Kumar Basu**  
 CONSULTING ARCHITECTS & ENGINEERS  
 4, BROAD STREET  
 KOLKATA-700019

DRAWN BY: MADHUMITA    CHECKED BY: RAJAJ BASU  
 SCALE: 1/300    SHEET NO.: 1 OF 8    DATE: 15/11/2017  
 DRAWING NO.: 28866/RAJAJANARCH/28866/2