

SCHEDULE OF DOORS & WINDOWS

TYPE	SILL	INSET	SIZE	TYPE	SILL	INSET	SIZE
D	100	100	1800x2100	W	100	200	1800x2100
D	100	100	1200x2100	W	100	200	1500x2100
D	100	100	1200x2100	W	100	200	1000x2100
D	100	100	1200x2100	W	100	200	1000x2100
GENERAL NOTES:
 1. ALL DIMENSIONS ARE IN MM.
 2. ALL EXTERNAL WALLS 200 THK. & INTERNAL WALLS 150 THK.
 3. ALL MASONRY WORKS ARE BOUNDED BY CEMENT MORTAR (1:6) & (1:4).
 4. EXTERNAL PLASTER IS 25 THK. & INTERNAL PLASTER IS 15 THK.
 5. ALL CONCRETE WORKS TO BE DONE AS PER IS 456:2000.
 6. ALL CONCRETE GRADE IS M30 (G15.3).

ASPS DEVELOPERS LLP
Aspirants Group
 CONSULTANTS

SIGNATURE OF OWNER
 CERTIFICATE OF GEOTECHNICAL ENGINEER
 THE GEOTECHNICAL INVESTIGATION HAS BEEN PREPARED BY THE REGISTERED PROFESSIONAL ENGINEER IN CIVIL ENGINEERING. THE REPORT, DESIGN AND CALCULATION OF THE FOUNDATION BY THE REGISTERED PROFESSIONAL ENGINEER IN CIVIL ENGINEERING. THE FOUNDATION DESIGN AND CALCULATION OF THE FOUNDATION BY THE REGISTERED PROFESSIONAL ENGINEER IN CIVIL ENGINEERING. THE FOUNDATION DESIGN AND CALCULATION OF THE FOUNDATION BY THE REGISTERED PROFESSIONAL ENGINEER IN CIVIL ENGINEERING.

For C. M. Engineering Company Pvt. Ltd.
 General Manager
 Dr. M. V. S. MD
 (M. E. CIVIL ENGINEER)

SIGNATURE OF STRUCTURAL ENGINEER
 CERTIFICATE OF STRUCTURAL ENGINEER
 I HAVE EXAMINED THE DRAWINGS AND FOUND THEM TO BE IN ACCORDANCE WITH THE REQUIREMENTS OF THE BUILDING REGULATIONS AND THE SPECIFICATIONS. I HAVE CONSIDERED ALL POSSIBLE LOADS INCLUDING THE SEISMIC LOADS AS PER THE APPLICABLE CODES OF PRACTICE. I HAVE FOUND THE STRUCTURE TO BE SAFE AND STABLE IN ALL RESPECTS. I AM NOT RESPONSIBLE FOR THE DESIGN OF THE FOUNDATION.

Utpal Santra
 UTPAL SANTRA
 (M. E. CIVIL ENGINEER)
 8, M. B. ROAD, TANKA, KOLKATA - 700046
 CONTACT NO. 9830111111

SIGNATURE OF ARCHITECT
 I HAVE EXAMINED THE DRAWINGS AND FOUND THEM TO BE IN ACCORDANCE WITH THE REQUIREMENTS OF THE BUILDING REGULATIONS AND THE SPECIFICATIONS. I HAVE CONSIDERED ALL POSSIBLE LOADS INCLUDING THE SEISMIC LOADS AS PER THE APPLICABLE CODES OF PRACTICE. I HAVE FOUND THE STRUCTURE TO BE SAFE AND STABLE IN ALL RESPECTS. I AM NOT RESPONSIBLE FOR THE DESIGN OF THE FOUNDATION.


Rajkumar Agarwal
 Architect
 Member of I.A.A.
 No. 17940
 Address: CA 17940

PROJECT
 PROPOSED PLAN OF C-XXIV (86.4 M. HT)
 STAGED RESIDENTIAL BUILDING AT PRE NO.
 45, CHRISTOPHER ROAD,
 WARD NO-58, BOROUGH-VII, P.S. TANGRA,
 KOLKATA-700046.

DATE: 17/03/18
 ARCH: 2018/361
 SHEET: 04 OF 13

DATE	DWG. NO.	DELT.	CHECKED	SHEET NO.	OK. OF
17/03/18	ARCH/2018/361	SMTH	NARMA	04 OF 13	

SCALE: 1:150
 ARCHITECT
 RAJ AGRAWAL & ASSOCIATES
 88, ROYD STREET, CALCUTTA - 16

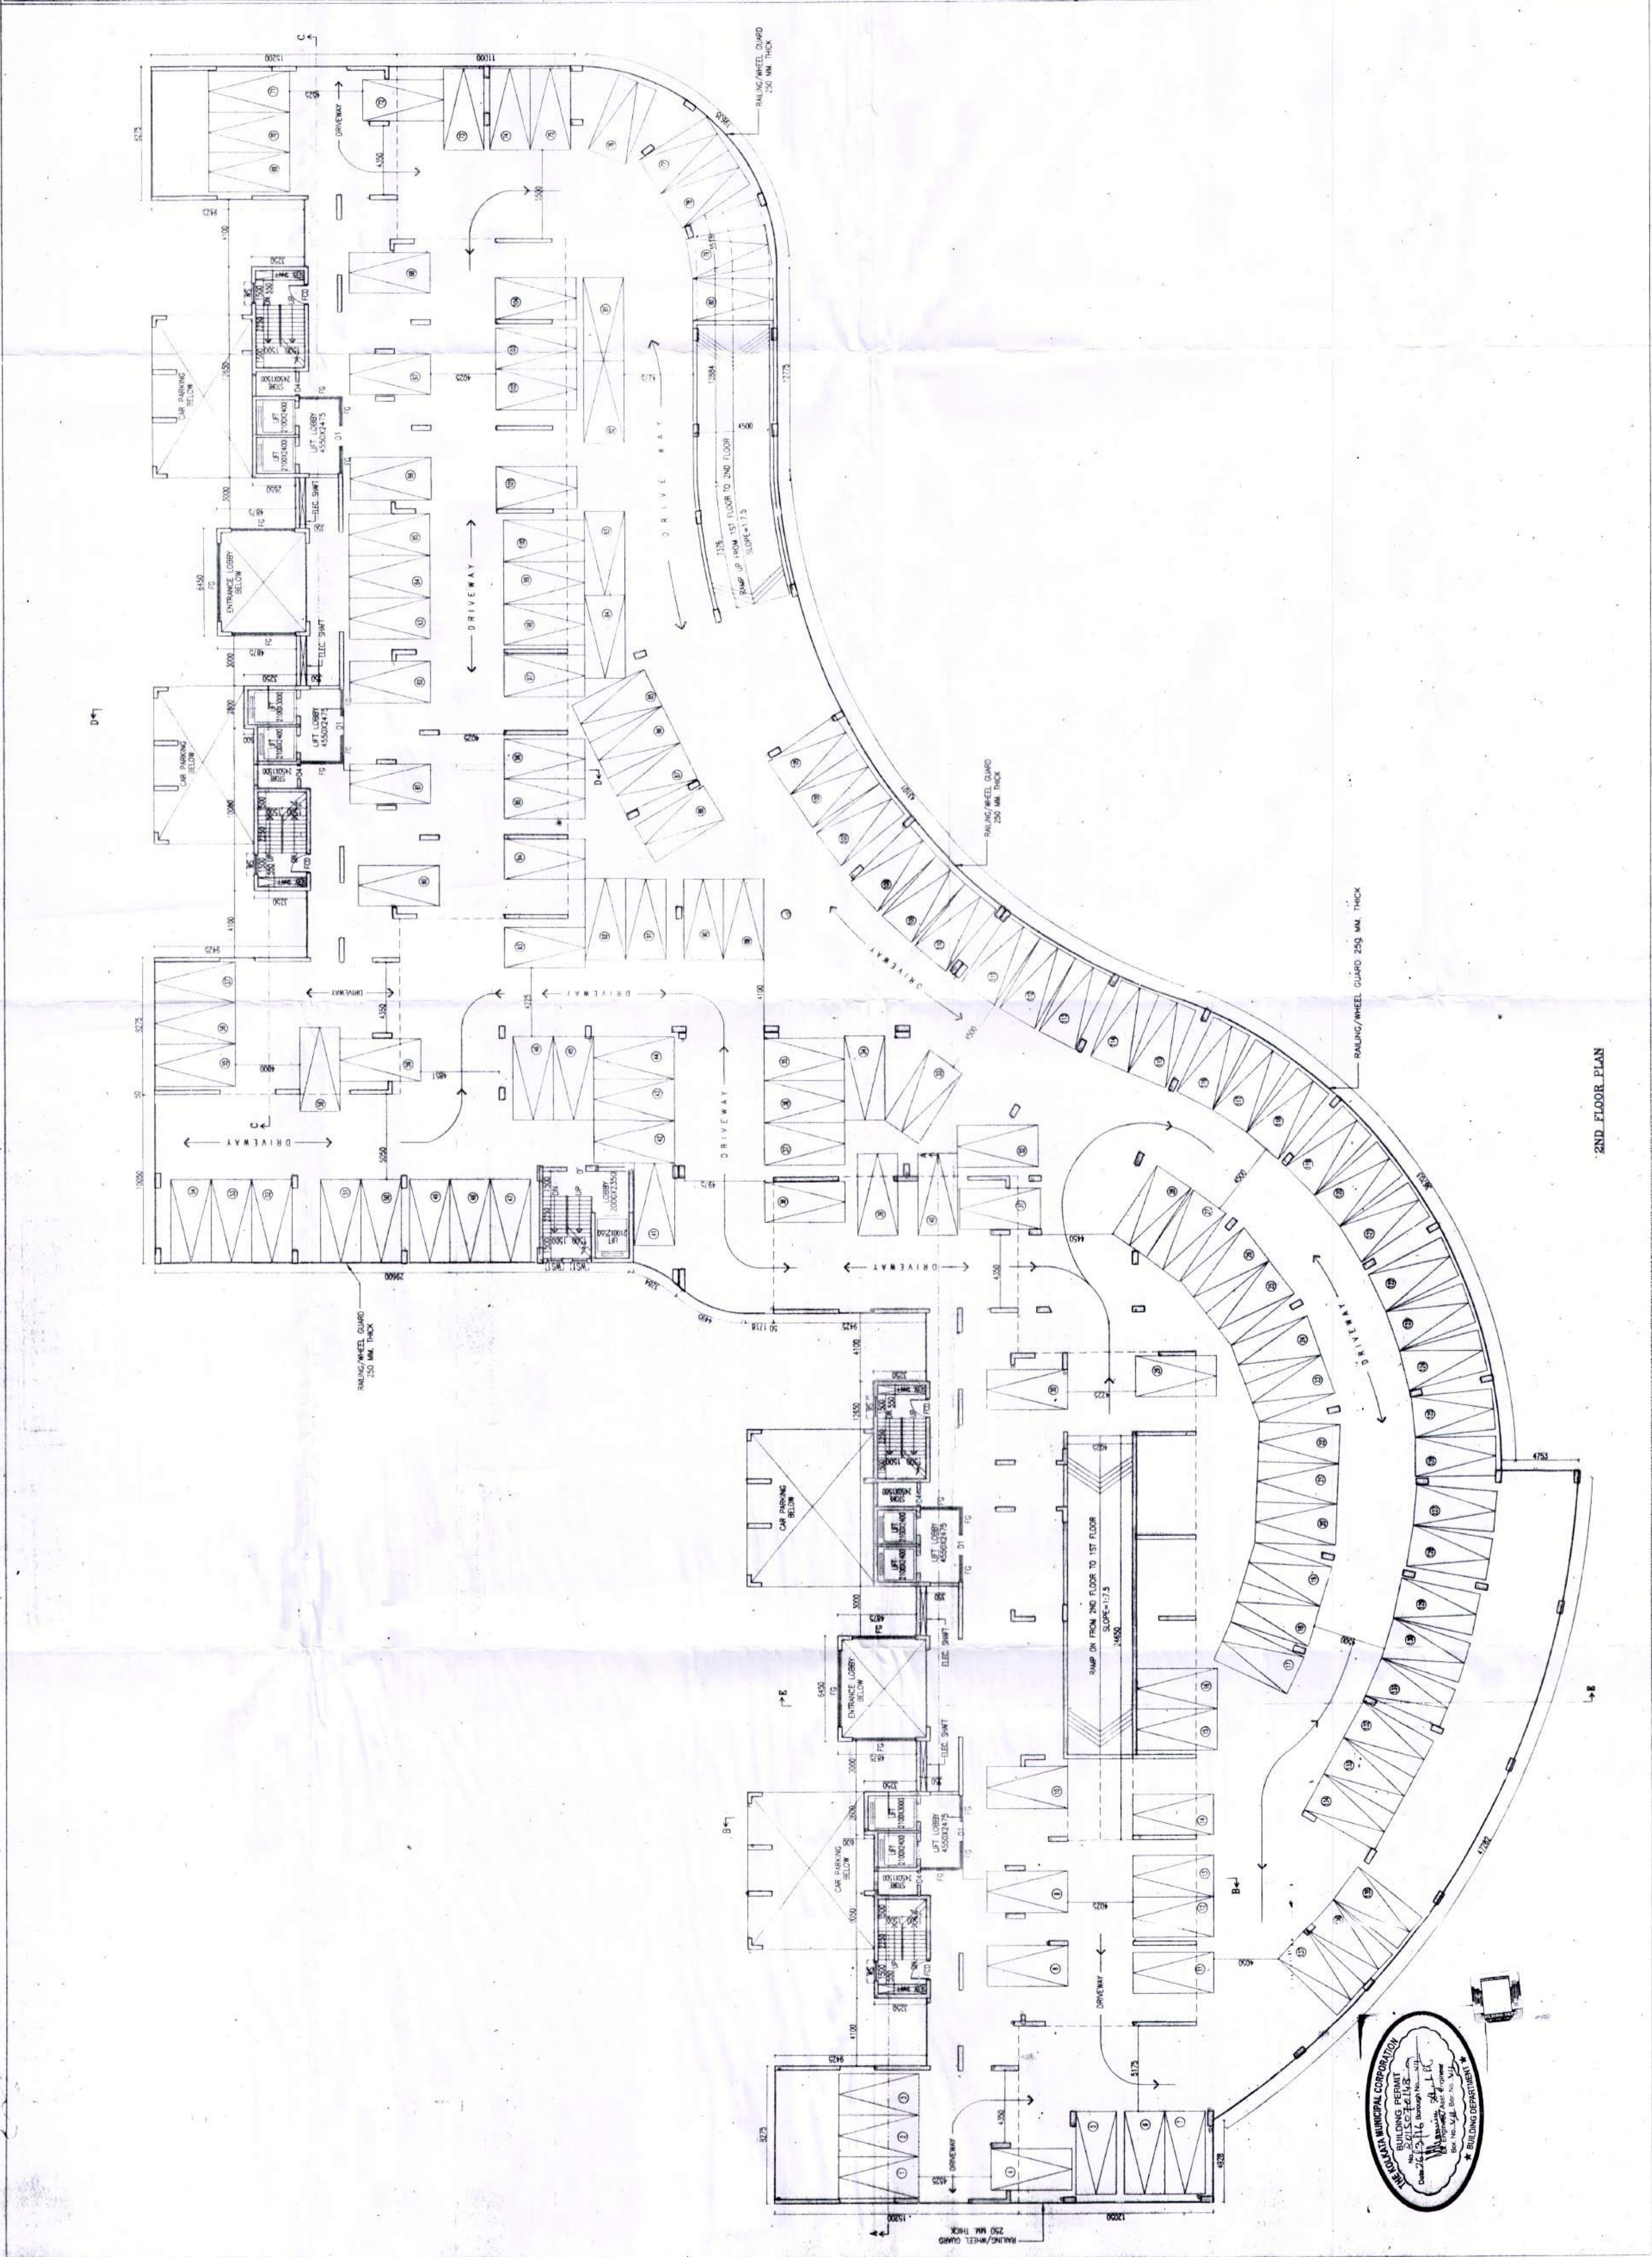

2ND FLOOR PLAN

