

**NOTES**

1. ALL DIMENSIONS ARE IN METERS UNLESS OTHERWISE SPECIFIED.

2. ALL WORK SHALL BE DONE IN ACCORDANCE WITH THE NATIONAL BUILDING CODE OF INDIA AND THE LOCAL LAWS AND REGULATIONS.

3. THE CONTRACTOR SHALL BE RESPONSIBLE FOR OBTAINING ALL NECESSARY PERMITS AND APPROVALS FROM THE LOCAL AUTHORITIES.

4. THE CONTRACTOR SHALL MAINTAIN ACCESS TO ALL ADJACENT PROPERTIES AT ALL TIMES.

5. THE CONTRACTOR SHALL BE RESPONSIBLE FOR THE PROTECTION OF ALL UTILITIES AND EXISTING STRUCTURES.

6. THE CONTRACTOR SHALL MAINTAIN A RECORD OF ALL WORK DONE AND SUBMIT IT TO THE ARCHITECT AT THE END OF THE PROJECT.

7. THE CONTRACTOR SHALL BE RESPONSIBLE FOR THE DISPOSAL OF ALL WASTE AND DEBRIS.

8. THE CONTRACTOR SHALL MAINTAIN A SAFE WORKING ENVIRONMENT AT ALL TIMES.

9. THE CONTRACTOR SHALL BE RESPONSIBLE FOR THE PROTECTION OF THE ENVIRONMENT.

10. THE CONTRACTOR SHALL MAINTAIN A RECORD OF ALL ACCIDENTS AND INJURIES.

11. THE CONTRACTOR SHALL BE RESPONSIBLE FOR THE PROTECTION OF ALL ADJACENT PROPERTIES.

12. THE CONTRACTOR SHALL MAINTAIN ACCESS TO ALL ADJACENT PROPERTIES AT ALL TIMES.

13. THE CONTRACTOR SHALL BE RESPONSIBLE FOR THE PROTECTION OF ALL UTILITIES AND EXISTING STRUCTURES.

14. THE CONTRACTOR SHALL MAINTAIN A RECORD OF ALL WORK DONE AND SUBMIT IT TO THE ARCHITECT AT THE END OF THE PROJECT.

15. THE CONTRACTOR SHALL BE RESPONSIBLE FOR THE DISPOSAL OF ALL WASTE AND DEBRIS.


16. THE CONTRACTOR SHALL MAINTAIN A SAFE WORKING ENVIRONMENT AT ALL TIMES.

17. THE CONTRACTOR SHALL BE RESPONSIBLE FOR THE PROTECTION OF THE ENVIRONMENT.

18. THE CONTRACTOR SHALL MAINTAIN A RECORD OF ALL ACCIDENTS AND INJURIES.

19. THE CONTRACTOR SHALL BE RESPONSIBLE FOR THE PROTECTION OF ALL ADJACENT PROPERTIES.

20. THE CONTRACTOR SHALL MAINTAIN ACCESS TO ALL ADJACENT PROPERTIES AT ALL TIMES.

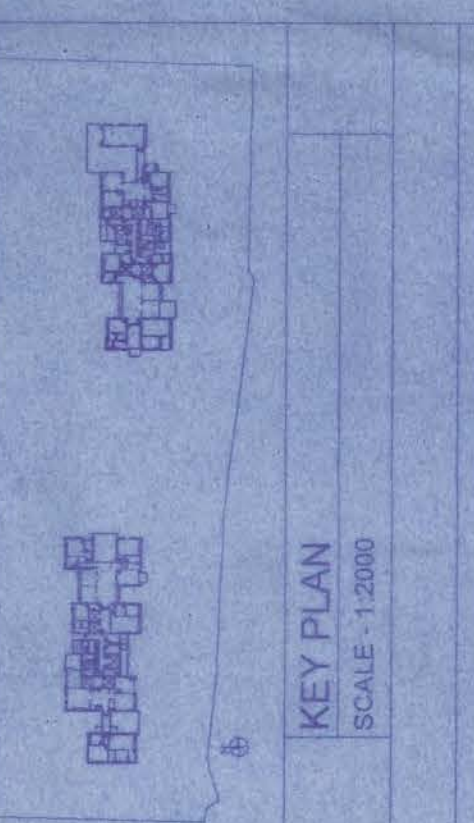

**CERTIFICATE OF STRUCTURAL ENGINEER**

THIS IS TO CERTIFY THAT THE STRUCTURAL DESIGN AND DRAWING OF BOTH FOUNDATION AND SUPER STRUCTURE OF THE BUILDING HAS BEEN MADE BY ME CONSIDERING ALL LOADS AS PER THE NATIONAL BUILDING CODE OF INDIA AND CERTIFIED THAT IT IS SAFE AND STABLE IN ALL RESPECTS.

*Utpal Saha*  
 Utpal Saha  
 Structural Engineer  
 Utpal Saha & Associates  
 11, C-1, Sector 1, Salt Lake, Kolkata-700061  
 91-98304-11111

**CERTIFICATE OF ARCHITECT**

THIS IS TO CERTIFY THAT THE BUILDING PLAN HAS BEEN DRAWN UP AS PER M.C. BUILDING RULE - 2005 AS AMENDED FROM TIME TO TIME.

THAT THE WIDTH OF THE ABUTTING ROAD CONFORM WITH THE PLAN AND IT IS A BUILDABLE SITE NOT A TANK OR A FILLED UP TANK.

THE SITE PLAN LOCATION IS IN ACCORDANCE WITH THE SITE PLAN IS IN ACCORDANCE WITH THE REGD. DEED PLAN THE EXISTING STRUCTURE AS SHOWN FULLY OCCUPIED BY OWNERS AS PER OWNERS UNDERTAKING.

*M. S. Prasad*  
 M. S. Prasad  
 Architect  
 M. S. Prasad & Associates  
 11, C-1, Sector 1, Salt Lake, Kolkata-700061  
 91-98304-11111

**CLIENT**

FORUM PROJECTS PVT. LTD.  
 11, C-1, Sector 1, Salt Lake, Kolkata-700061.

**PROPOSED ADDITION OF TWO FLOORS US 304 OF M.C. ACT, 1980 READ WITH U.R. 89A OF M.C. ACT, 1980 AND U.R. 89B OF M.C. ACT, 1980. THE PROPOSED ADDITION IS SANCTIONED BY M.C. AS PER EXISTING RESIDENTIAL BUILDING INCLUDING ALTERATIONS UR 24(6) & 2(5) OF KOLKATA MUNICIPAL CORPORATION BUILDING REGULATIONS, 1956. EASTERN METROPOLITAN BYE LAWS, WARD NO. 68, BOROUGH - VII, KOLKATA - 700 045.**


Reference: Permit issued by M.C. vide B.P. No. 20/11/07/25 dated 25.05.2011  
 (a) Subsequent to the issue of the permit, the owner has submitted the necessary documents for the sanction of the proposed addition of two floors.  
 (b) The proposed addition of two floors is in accordance with the provisions of the M.C. Act, 1980 and the U.R. 89A & 89B of the M.C. Act, 1980.  
 (c) The proposed addition of two floors is in accordance with the provisions of the Eastern Metropolitan Byelaws, Ward No. 68, Borough - VII, Kolkata - 700 045.  
 (d) The proposed addition of two floors is in accordance with the provisions of the Municipal Corporation Building Regulations, 1956.  
 (e) The proposed addition of two floors is in accordance with the provisions of the National Building Code of India.

**DESIGN ARCHITECT**


arc studio  
 11, C-1, Sector 1, Salt Lake, Kolkata-700061.

**RESUBMISSION TO M.C.**

STAGE: MUNICIPAL  
 DIRECTION: N  
 Drawing No: 16 of 26  
 Issue Date: 27-JULY-18  
 Last saved Date: 27-JULY-18  
 Project Code: FP/28  
 Wing/Block: WING-A AND WING-B  
 Floor: FLOOR PLAN  
 Drawing Title: FLOOR PLAN AT LEVEL-20.25

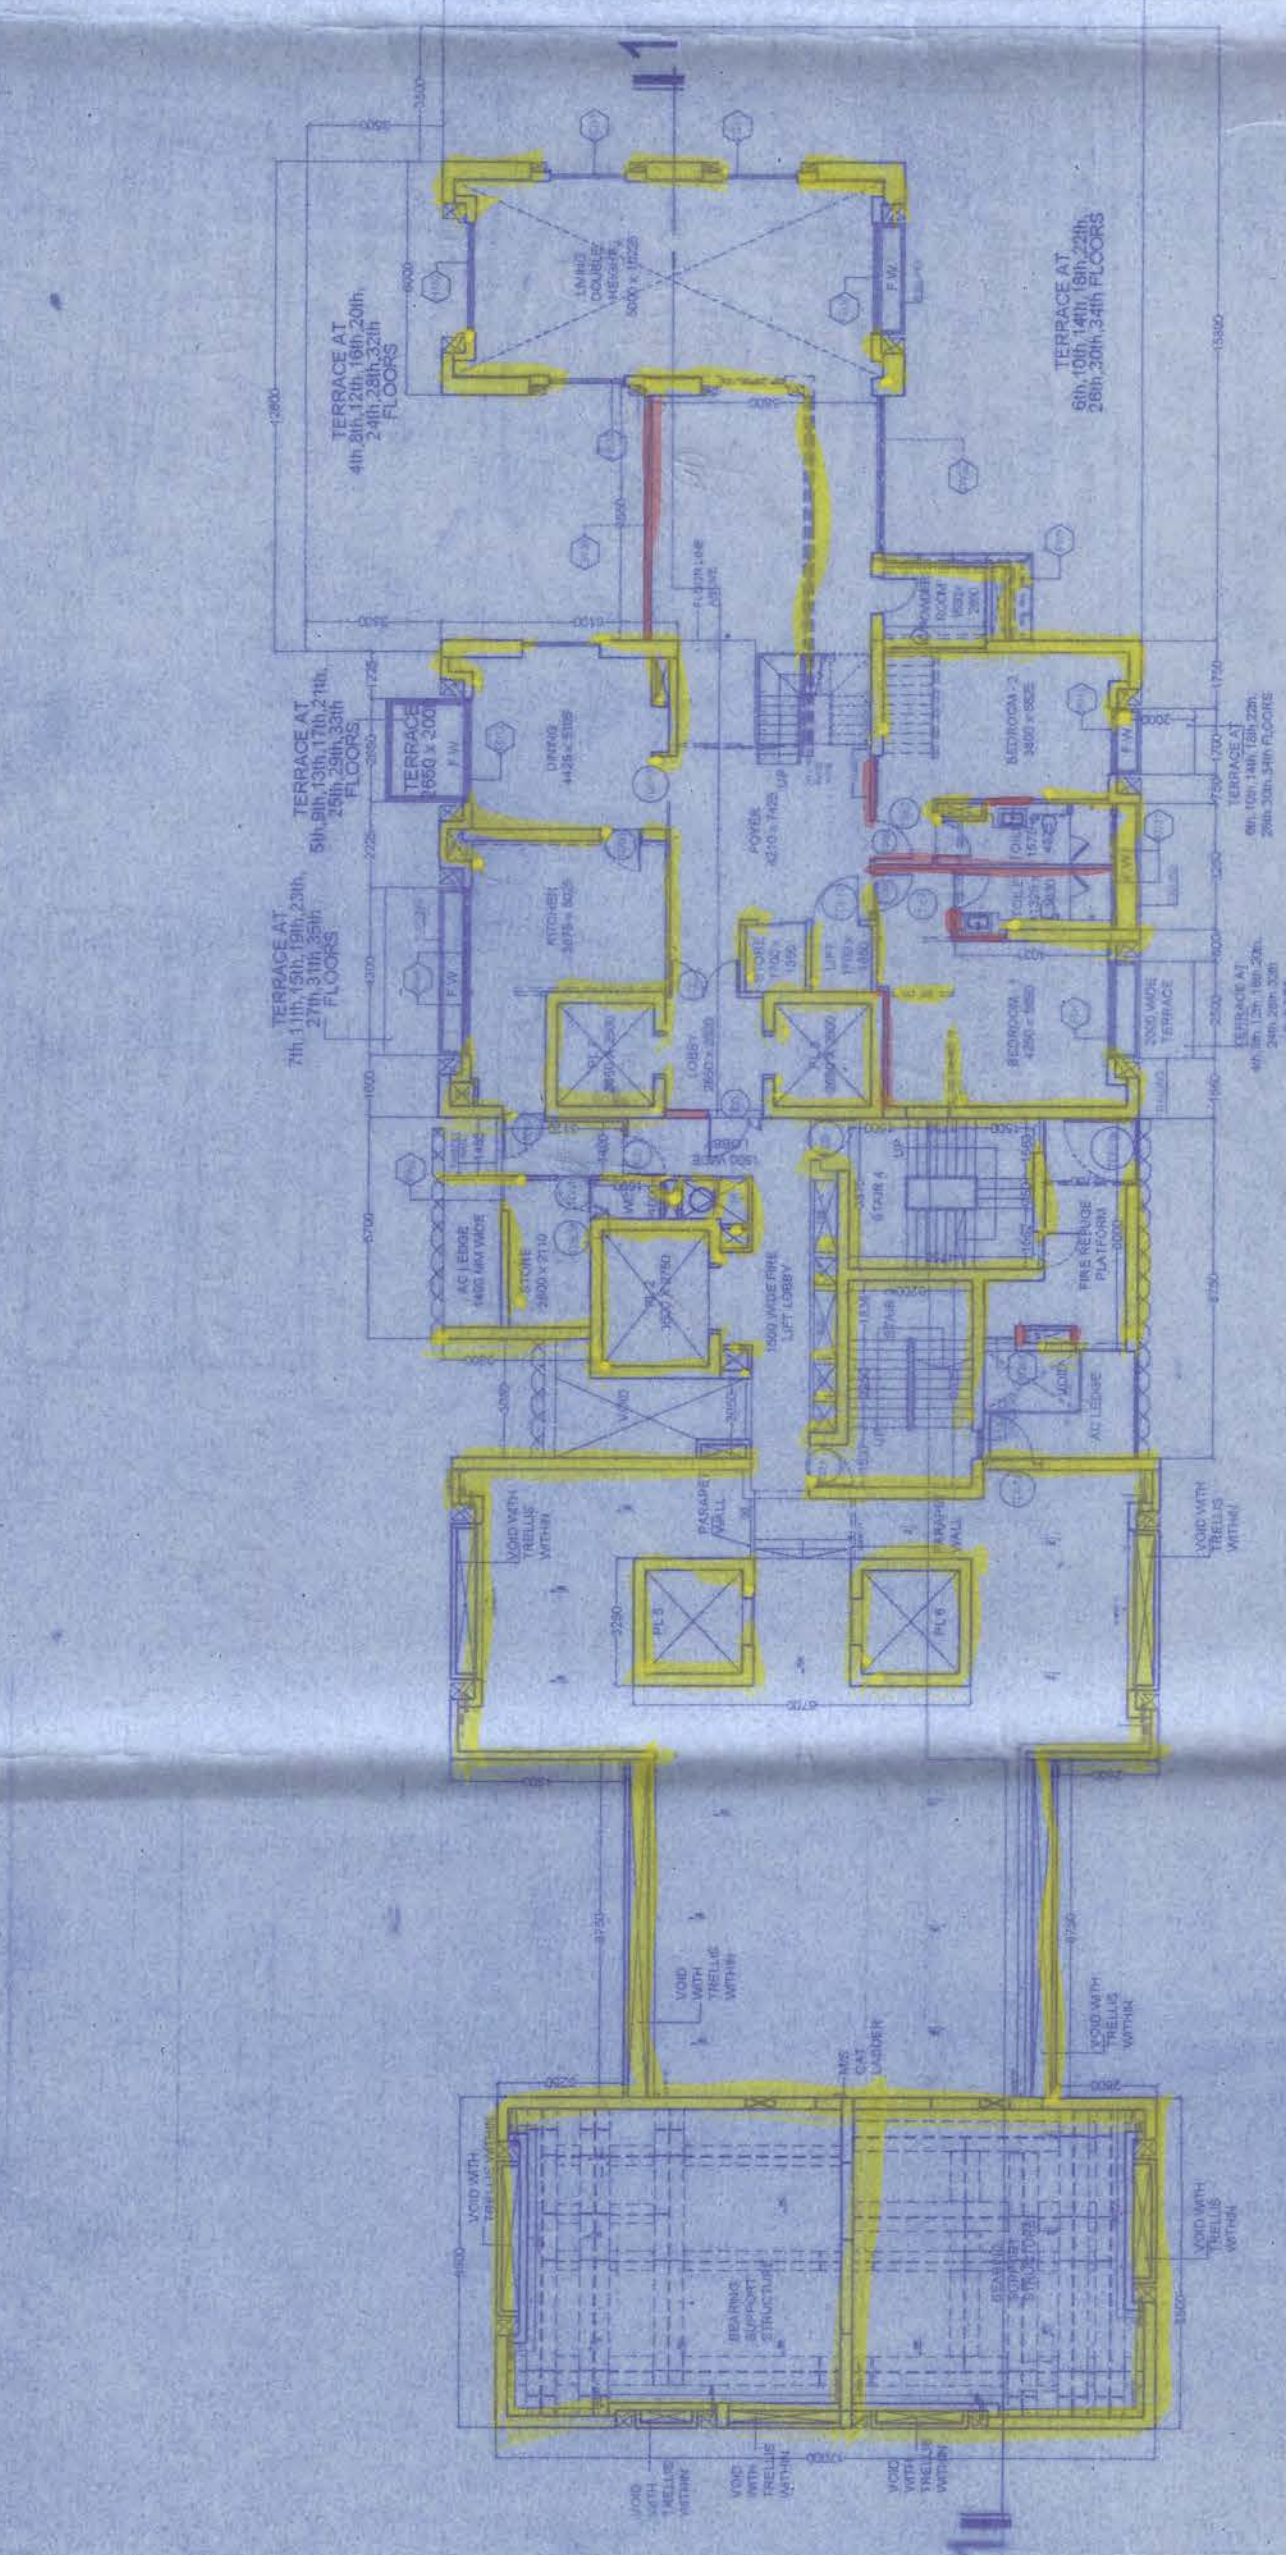


WING B - FLOOR AT LEVEL- 28TH-LEV (+) 96.76 M  
 scale 1:200

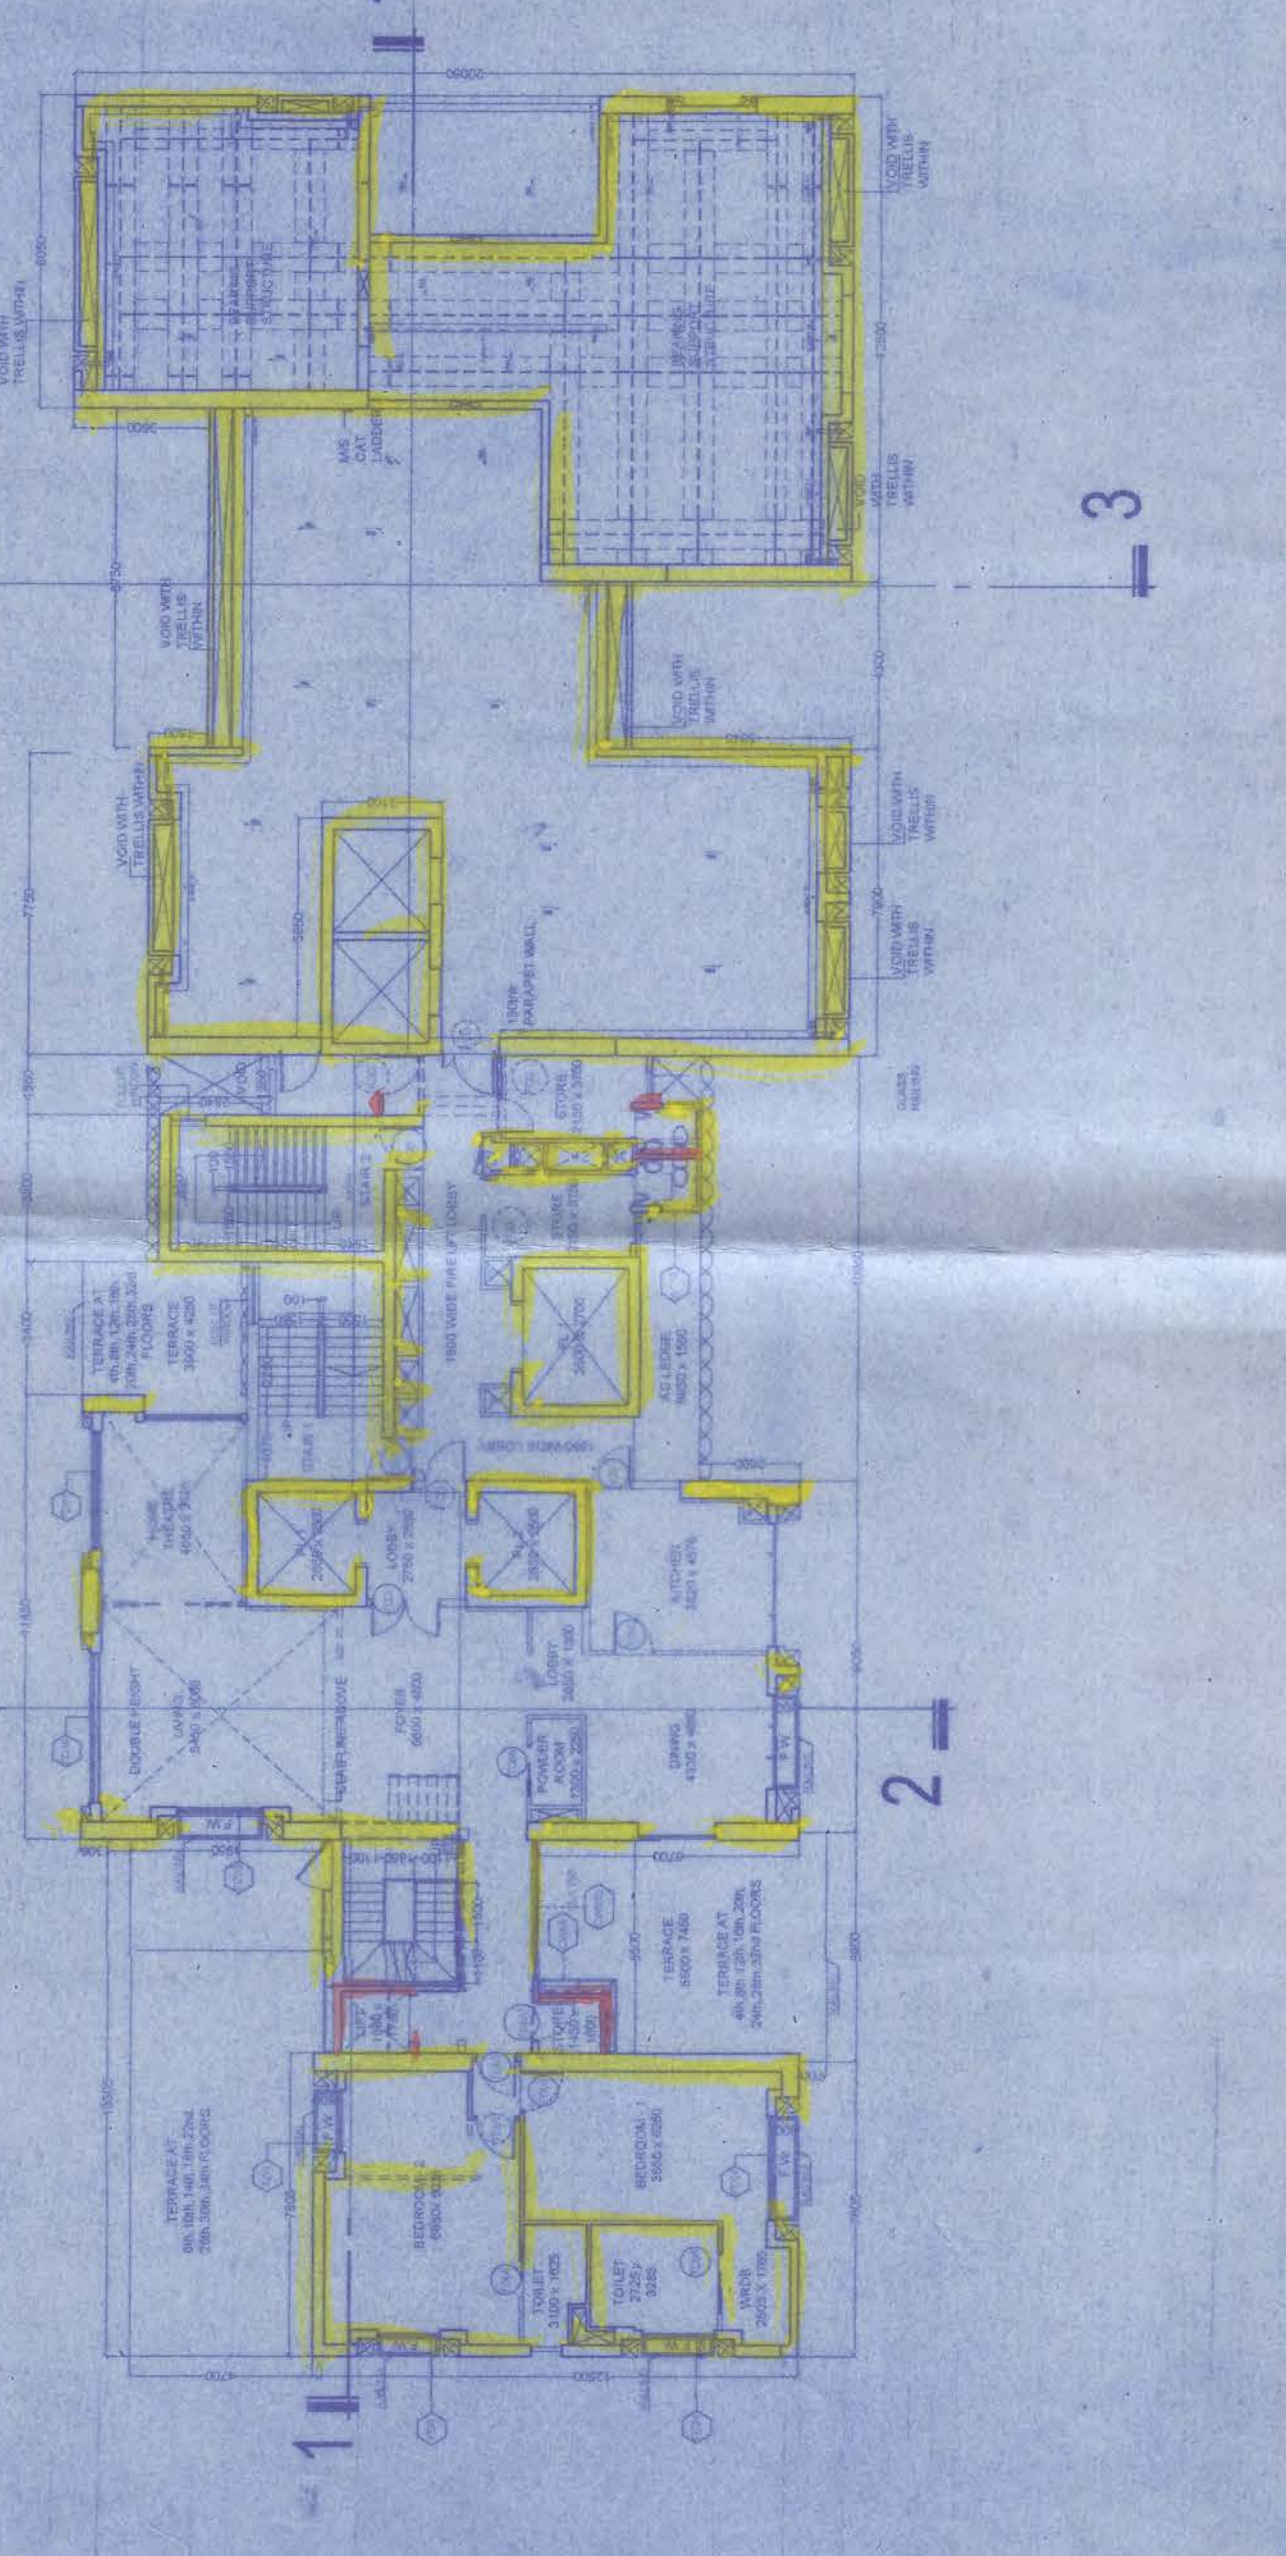

WING B - FLOOR AT LEVEL- 29TH- LVL (+) 100.16 M  
 scale 1:200


**SCHEDULE OF OPENINGS (DOORS) - ALUMINIUM**

Sl. No.	Room	Door Type	Material	Size (H x W)
1	101	ALUMINIUM FRAME GLASS SLIDING DOOR	ALUMINIUM	2000 x 2400
2	102	ALUMINIUM FRAME GLASS SLIDING DOOR	ALUMINIUM	2000 x 2400
3	103	ALUMINIUM FRAME GLASS SLIDING DOOR	ALUMINIUM	2000 x 2400
4	104	ALUMINIUM FRAME GLASS SLIDING DOOR	ALUMINIUM	2000 x 2400
5	105	ALUMINIUM FRAME GLASS SLIDING DOOR	ALUMINIUM	2000 x 2400
6	106	ALUMINIUM FRAME GLASS SLIDING DOOR	ALUMINIUM	2000 x 2400
7	107	ALUMINIUM FRAME GLASS SLIDING DOOR	ALUMINIUM	2000 x 2400
8	108	ALUMINIUM FRAME GLASS SLIDING DOOR	ALUMINIUM	2000 x 2400
9	109	ALUMINIUM FRAME GLASS SLIDING DOOR	ALUMINIUM	2000 x 2400
10	110	ALUMINIUM FRAME GLASS SLIDING DOOR	ALUMINIUM	2000 x 2400
11	111	ALUMINIUM FRAME GLASS SLIDING DOOR	ALUMINIUM	2000 x 2400
12	112	ALUMINIUM FRAME GLASS SLIDING DOOR	ALUMINIUM	2000 x 2400
13	113	ALUMINIUM FRAME GLASS SLIDING DOOR	ALUMINIUM	2000 x 2400
14	114	ALUMINIUM FRAME GLASS SLIDING DOOR	ALUMINIUM	2000 x 2400
15	115	ALUMINIUM FRAME GLASS SLIDING DOOR	ALUMINIUM	2000 x 2400
16	116	ALUMINIUM FRAME GLASS SLIDING DOOR	ALUMINIUM	2000 x 2400
17	117	ALUMINIUM FRAME GLASS SLIDING DOOR	ALUMINIUM	2000 x 2400
18	118	ALUMINIUM FRAME GLASS SLIDING DOOR	ALUMINIUM	2000 x 2400
19	119	ALUMINIUM FRAME GLASS SLIDING DOOR	ALUMINIUM	2000 x 2400
20	120	ALUMINIUM FRAME GLASS SLIDING DOOR	ALUMINIUM	2000 x 2400
21	121	ALUMINIUM FRAME GLASS SLIDING DOOR	ALUMINIUM	2000 x 2400
22	122	ALUMINIUM FRAME GLASS SLIDING DOOR	ALUMINIUM	2000 x 2400
23	123	ALUMINIUM FRAME GLASS SLIDING DOOR	ALUMINIUM	2000 x 2400
24	124	ALUMINIUM FRAME GLASS SLIDING DOOR	ALUMINIUM	2000 x 2400
25	125	ALUMINIUM FRAME GLASS SLIDING DOOR	ALUMINIUM	2000 x 2400
26	126	ALUMINIUM FRAME GLASS SLIDING DOOR	ALUMINIUM	2000 x 2400
27	127	ALUMINIUM FRAME GLASS SLIDING DOOR	ALUMINIUM	2000 x 2400
28	128	ALUMINIUM FRAME GLASS SLIDING DOOR	ALUMINIUM	2000 x 2400
29	129	ALUMINIUM FRAME GLASS SLIDING DOOR	ALUMINIUM	2000 x 2400
30	130	ALUMINIUM FRAME GLASS SLIDING DOOR	ALUMINIUM	2000 x 2400
31	131	ALUMINIUM FRAME GLASS SLIDING DOOR	ALUMINIUM	2000 x 2400
32	132	ALUMINIUM FRAME GLASS SLIDING DOOR	ALUMINIUM	2000 x 2400
33	133	ALUMINIUM FRAME GLASS SLIDING DOOR	ALUMINIUM	2000 x 2400
34	134	ALUMINIUM FRAME GLASS SLIDING DOOR	ALUMINIUM	2000 x 2400
35	135	ALUMINIUM FRAME GLASS SLIDING DOOR	ALUMINIUM	2000 x 2400
36	136	ALUMINIUM FRAME GLASS SLIDING DOOR	ALUMINIUM	2000 x 2400
37	137	ALUMINIUM FRAME GLASS SLIDING DOOR	ALUMINIUM	2000 x 2400
38	138	ALUMINIUM FRAME GLASS SLIDING DOOR	ALUMINIUM	2000 x 2400
39	139	ALUMINIUM FRAME GLASS SLIDING DOOR	ALUMINIUM	2000 x 2400
40	140	ALUMINIUM FRAME GLASS SLIDING DOOR	ALUMINIUM	2000 x 2400
41	141	ALUMINIUM FRAME GLASS SLIDING DOOR	ALUMINIUM	2000 x 2400
42	142	ALUMINIUM FRAME GLASS SLIDING DOOR	ALUMINIUM	2000 x 2400
43	143	ALUMINIUM FRAME GLASS SLIDING DOOR	ALUMINIUM	2000 x 2400
44	144	ALUMINIUM FRAME GLASS SLIDING DOOR	ALUMINIUM	2000 x 2400
45	145	ALUMINIUM FRAME GLASS SLIDING DOOR	ALUMINIUM	2000 x 2400
46	146	ALUMINIUM FRAME GLASS SLIDING DOOR	ALUMINIUM	2000 x 2400
47	147	ALUMINIUM FRAME GLASS SLIDING DOOR	ALUMINIUM	2000 x 2400
48	148	ALUMINIUM FRAME GLASS SLIDING DOOR	ALUMINIUM	2000 x 2400
49	149	ALUMINIUM FRAME GLASS SLIDING DOOR	ALUMINIUM	2000 x 2400
50	150	ALUMINIUM FRAME GLASS SLIDING DOOR	ALUMINIUM	2000 x 2400

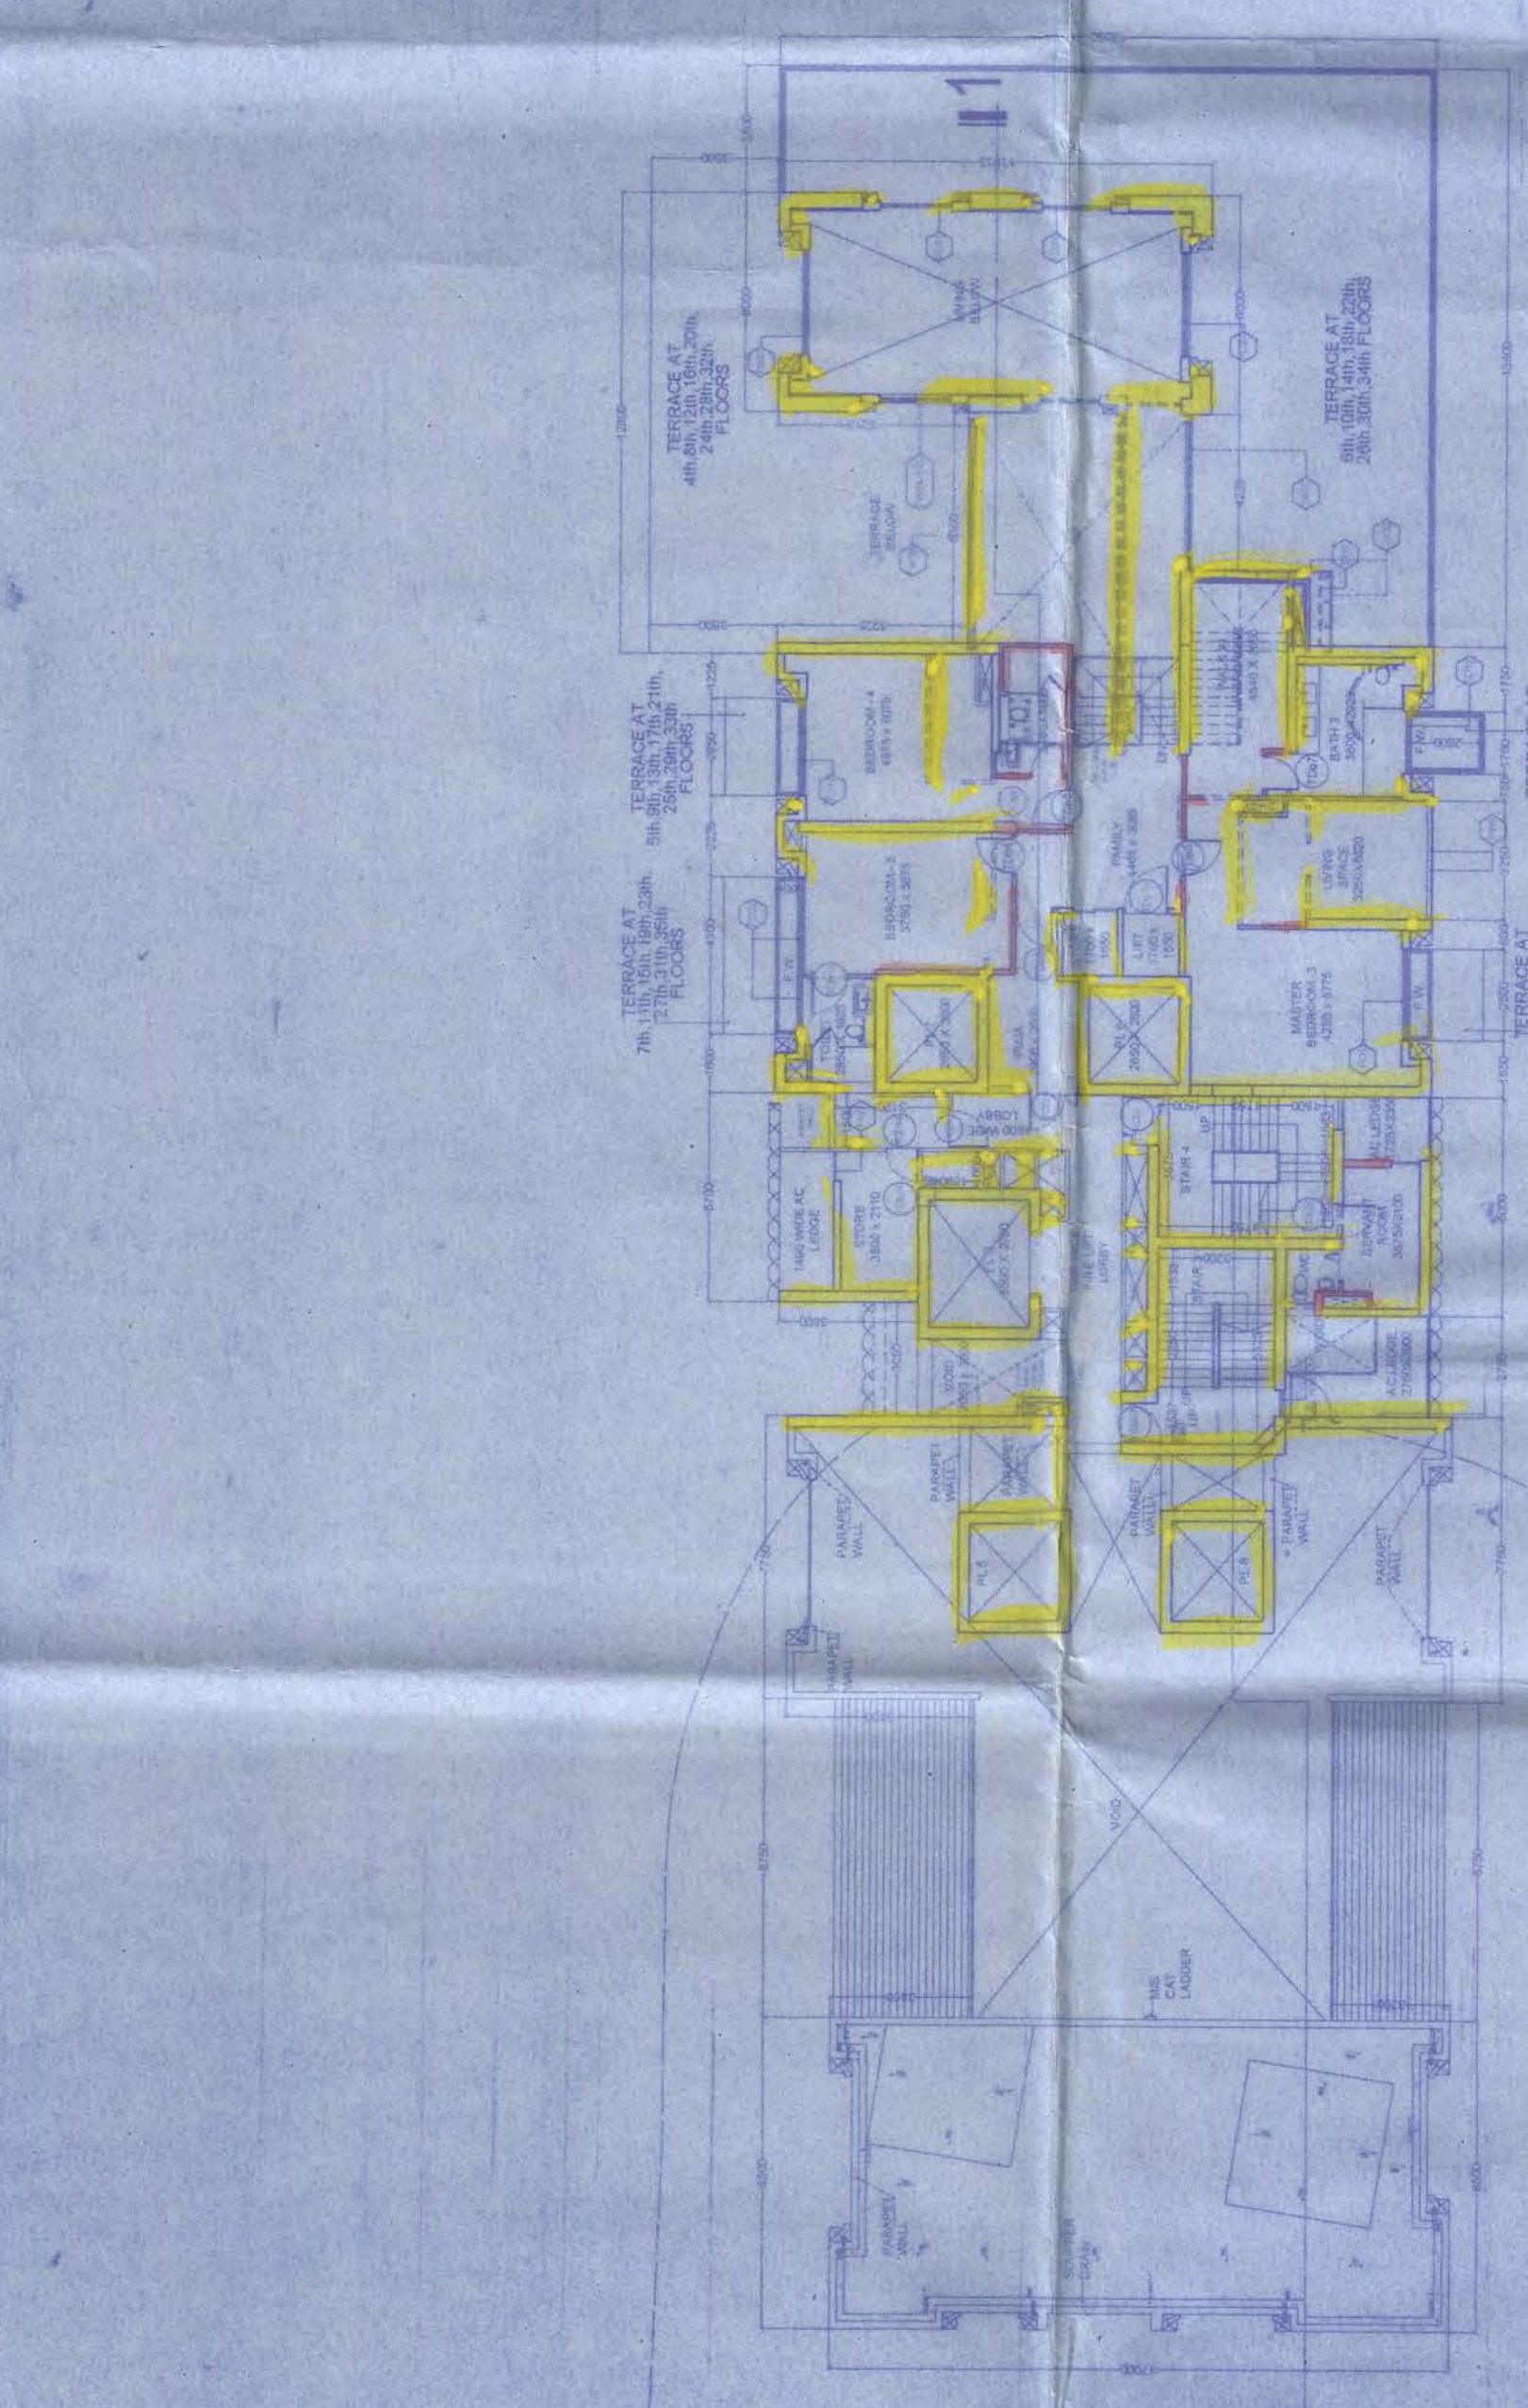

**SCHEDULE OF OPENINGS (WINDOWS) - ALUMINIUM**

Sl. No.	Room	Window Type	Material	Size (H x W)
1	101	ALUMINIUM FRAME GLASS WINDOW	ALUMINIUM	1200 x 1500
2	102	ALUMINIUM FRAME GLASS WINDOW	ALUMINIUM	1200 x 1500
3	103	ALUMINIUM FRAME GLASS WINDOW	ALUMINIUM	1200 x 1500
4	104	ALUMINIUM FRAME GLASS WINDOW	ALUMINIUM	1200 x 1500
5	105	ALUMINIUM FRAME GLASS WINDOW	ALUMINIUM	1200 x 1500
6	106	ALUMINIUM FRAME GLASS WINDOW	ALUMINIUM	1200 x 1500
7	107	ALUMINIUM FRAME GLASS WINDOW	ALUMINIUM	1200 x 1500
8	108	ALUMINIUM FRAME GLASS WINDOW	ALUMINIUM	1200 x 1500
9	109	ALUMINIUM FRAME GLASS WINDOW	ALUMINIUM	1200 x 1500
10	110	ALUMINIUM FRAME GLASS WINDOW	ALUMINIUM	1200 x 1500
11	111	ALUMINIUM FRAME GLASS WINDOW	ALUMINIUM	1200 x 1500
12	112	ALUMINIUM FRAME GLASS WINDOW	ALUMINIUM	1200 x 1500
13	113	ALUMINIUM FRAME GLASS WINDOW	ALUMINIUM	1200 x 1500
14	114	ALUMINIUM FRAME GLASS WINDOW	ALUMINIUM	1200 x 1500
15	115	ALUMINIUM FRAME GLASS WINDOW	ALUMINIUM	1200 x 1500
16	116	ALUMINIUM FRAME GLASS WINDOW	ALUMINIUM	1200 x 1500
17	117	ALUMINIUM FRAME GLASS WINDOW	ALUMINIUM	1200 x 1500
18	118	ALUMINIUM FRAME GLASS WINDOW	ALUMINIUM	1200 x 1500
19	119	ALUMINIUM FRAME GLASS WINDOW	ALUMINIUM	1200 x 1500
20	120	ALUMINIUM FRAME GLASS WINDOW	ALUMINIUM	1200 x 1500
21	121	ALUMINIUM FRAME GLASS WINDOW	ALUMINIUM	1200 x 1500
22	122	ALUMINIUM FRAME GLASS WINDOW	ALUMINIUM	1200 x 1500
23	123	ALUMINIUM FRAME GLASS WINDOW	ALUMINIUM	1200 x 1500
24	124	ALUMINIUM FRAME GLASS WINDOW	ALUMINIUM	1200 x 1500
25	125	ALUMINIUM FRAME GLASS WINDOW	ALUMINIUM	1200 x 1500
26	126	ALUMINIUM FRAME GLASS WINDOW	ALUMINIUM	1200 x 1500
27	127	ALUMINIUM FRAME GLASS WINDOW	ALUMINIUM	1200 x 1500
28	128	ALUMINIUM FRAME GLASS WINDOW	ALUMINIUM	1200 x 1500
29	129	ALUMINIUM FRAME GLASS WINDOW	ALUMINIUM	1200 x 1500
30	130	ALUMINIUM FRAME GLASS WINDOW	ALUMINIUM	1200 x 1500
31	131	ALUMINIUM FRAME GLASS WINDOW	ALUMINIUM	1200 x 1500
32	132	ALUMINIUM FRAME GLASS WINDOW	ALUMINIUM	1200 x 1500
33	133	ALUMINIUM FRAME GLASS WINDOW	ALUMINIUM	1200 x 1500
34	134	ALUMINIUM FRAME GLASS WINDOW	ALUMINIUM	1200 x 1500
35	135	ALUMINIUM FRAME GLASS WINDOW	ALUMINIUM	1200 x 1500
36	136	ALUMINIUM FRAME GLASS WINDOW	ALUMINIUM	1200 x 1500
37	137	ALUMINIUM FRAME GLASS WINDOW	ALUMINIUM	1200 x 1500
38	138	ALUMINIUM FRAME GLASS WINDOW	ALUMINIUM	1200 x 1500
39	139	ALUMINIUM FRAME GLASS WINDOW	ALUMINIUM	1200 x 1500
40	140	ALUMINIUM FRAME GLASS WINDOW	ALUMINIUM	1200 x 1500
41	141	ALUMINIUM FRAME GLASS WINDOW	ALUMINIUM	1200 x 1500
42	142	ALUMINIUM FRAME GLASS WINDOW	ALUMINIUM	1200 x 1500
43	143	ALUMINIUM FRAME GLASS WINDOW	ALUMINIUM	1200 x 1500
44	144	ALUMINIUM FRAME GLASS WINDOW	ALUMINIUM	1200 x 1500
45	145	ALUMINIUM FRAME GLASS WINDOW	ALUMINIUM	1200 x 1500
46	146	ALUMINIUM FRAME GLASS WINDOW	ALUMINIUM	1200 x 1500
47	147	ALUMINIUM FRAME GLASS WINDOW	ALUMINIUM	1200 x 1500
48	148	ALUMINIUM FRAME GLASS WINDOW	ALUMINIUM	1200 x 1500
49	149	ALUMINIUM FRAME GLASS WINDOW	ALUMINIUM	1200 x 1500
50	150	ALUMINIUM FRAME GLASS WINDOW	ALUMINIUM	1200 x 1500

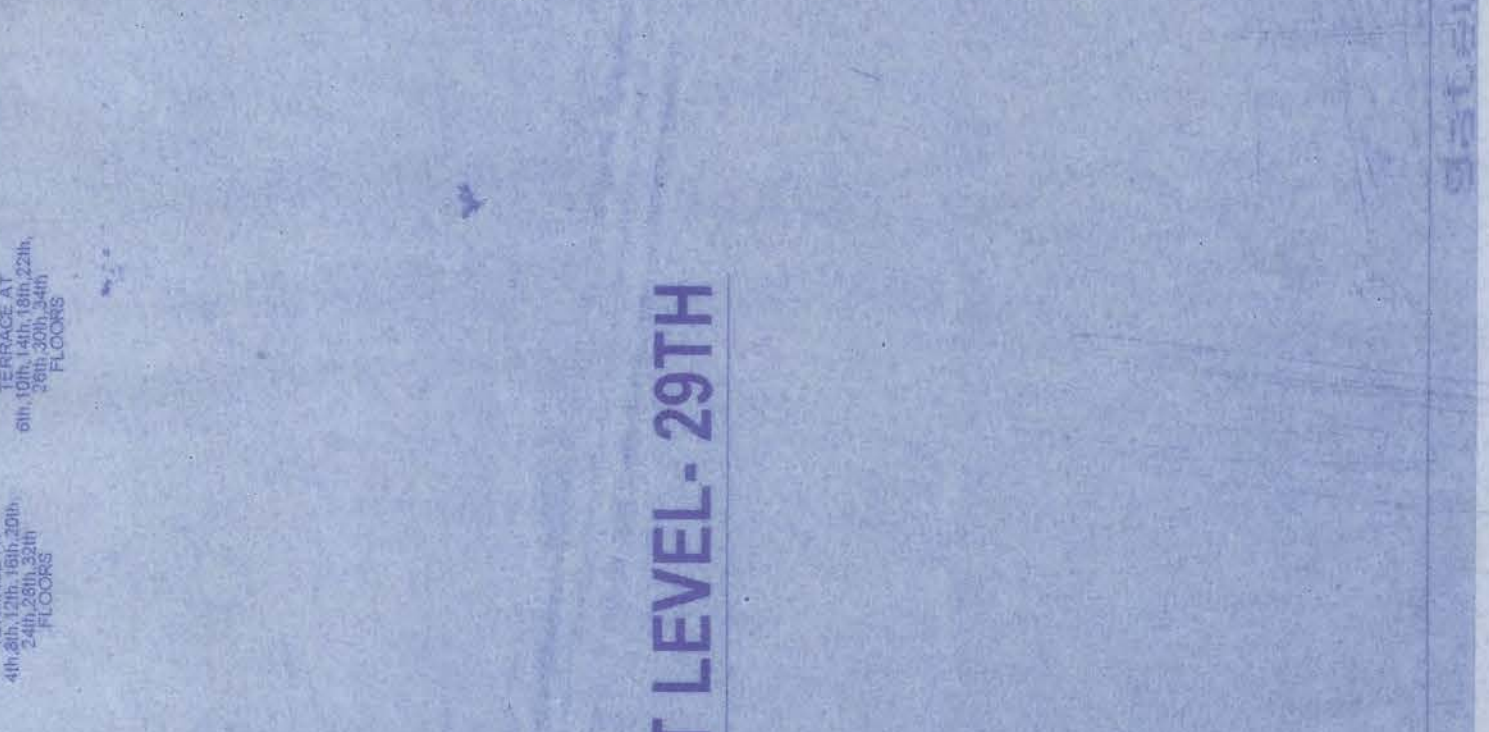

**SCHEDULE OF OPENINGS (DOORS) - TIMBER**

Sl. No.	Room	Door Type	Material	Size (H x W)
1	101	TIMBER FRAME GLASS SLIDING DOOR	TIMBER	2000 x 2400
2	102	TIMBER FRAME GLASS SLIDING DOOR	TIMBER	2000 x 2400
3	103	TIMBER FRAME GLASS SLIDING DOOR	TIMBER	2000 x 2400
4	104	TIMBER FRAME GLASS SLIDING DOOR	TIMBER	2000 x 2400
5	105	TIMBER FRAME GLASS SLIDING DOOR	TIMBER	2000 x 2400
6	106	TIMBER FRAME GLASS SLIDING DOOR	TIMBER	2000 x 2400
7	107	TIMBER FRAME GLASS SLIDING DOOR	TIMBER	2000 x 2400
8	108	TIMBER FRAME GLASS SLIDING DOOR	TIMBER	2000 x 2400
9	109	TIMBER FRAME GLASS SLIDING DOOR	TIMBER	2000 x 2400
10	110	TIMBER FRAME GLASS SLIDING DOOR	TIMBER	2000 x 2400
11	111	TIMBER FRAME GLASS SLIDING DOOR	TIMBER	2000 x 2400
12	112	TIMBER FRAME GLASS SLIDING DOOR	TIMBER	2000 x 2400
13	113	TIMBER FRAME GLASS SLIDING DOOR	TIMBER	2000 x 2400
14	114	TIMBER FRAME GLASS SLIDING DOOR	TIMBER	2000 x 2400
15	115	TIMBER FRAME GLASS SLIDING DOOR	TIMBER	2000 x 2400
16	116	TIMBER FRAME GLASS SLIDING DOOR	TIMBER	2000 x 2400
17	117	TIMBER FRAME GLASS SLIDING DOOR	TIMBER	2000 x 2400
18	118	TIMBER FRAME GLASS SLIDING DOOR	TIMBER	2000 x 2400
19	119	TIMBER FRAME GLASS SLIDING DOOR	TIMBER	2000 x 2400
20	120	TIMBER FRAME GLASS SLIDING DOOR	TIMBER	2000 x 2400
21	121	TIMBER FRAME GLASS SLIDING DOOR	TIMBER	2000 x 2400
22	122	TIMBER FRAME GLASS SLIDING DOOR	TIMBER	2000 x 2400
23	123	TIMBER FRAME GLASS SLIDING DOOR	TIMBER	2000 x 2400
24	124	TIMBER FRAME GLASS SLIDING DOOR	TIMBER	2000 x 2400
25	125	TIMBER FRAME GLASS SLIDING DOOR	TIMBER	2000 x 2400
26	126	TIMBER FRAME GLASS SLIDING DOOR	TIMBER	2000 x 2400
27	127	TIMBER FRAME GLASS SLIDING DOOR	TIMBER	2000 x 2400
28	128	TIMBER FRAME GLASS SLIDING DOOR	TIMBER	2000 x 2400
29	129	TIMBER FRAME GLASS SLIDING DOOR	TIMBER	2000 x 2400
30	130	TIMBER FRAME GLASS SLIDING DOOR	TIMBER	2000 x 2400
31	131	TIMBER FRAME GLASS SLIDING DOOR	TIMBER	2000 x 2400
32	132	TIMBER FRAME GLASS SLIDING DOOR	TIMBER	2000 x 2400
33	133	TIMBER FRAME GLASS SLIDING DOOR	TIMBER	2000 x 2400
34	134	TIMBER FRAME GLASS SLIDING DOOR	TIMBER	2000 x 2400
35	135	TIMBER FRAME GLASS SLIDING DOOR	TIMBER	2000 x 2400
36	136	TIMBER FRAME GLASS SLIDING DOOR	TIMBER	2000 x 2400
37	137	TIMBER FRAME GLASS SLIDING DOOR	TIMBER	2000 x 2400
38	138	TIMBER FRAME GLASS SLIDING DOOR	TIMBER	2000 x 2400
39	139	TIMBER FRAME GLASS SLIDING DOOR	TIMBER	2000 x 2400
40	140	TIMBER FRAME GLASS SLIDING DOOR	TIMBER	2000 x 2400
41	141	TIMBER FRAME GLASS SLIDING DOOR	TIMBER	2000 x 2400
42	142	TIMBER FRAME GLASS SLIDING DOOR	TIMBER	2000 x 2400
43	143	TIMBER FRAME GLASS SLIDING DOOR	TIMBER	2000 x 2400
44	144	TIMBER FRAME GLASS SLIDING DOOR	TIMBER	2000 x 2400
45	145	TIMBER FRAME GLASS SLIDING DOOR	TIMBER	2000 x 2400
46	146	TIMBER FRAME GLASS SLIDING DOOR	TIMBER	2000 x 2400
47	147	TIMBER FRAME GLASS SLIDING DOOR	TIMBER	2000 x 2400
48	148	TIMBER FRAME GLASS SLIDING DOOR	TIMBER	2000 x 2400
49	149	TIMBER FRAME GLASS SLIDING DOOR	TIMBER	2000 x 2400
50	150	TIMBER FRAME GLASS SLIDING DOOR	TIMBER	2000 x 2400

**SCHEDULE OF OPENINGS (WINDOWS) - TIMBER**

Sl. No.	Room	Window Type	Material	Size (H x W)
1	101	TIMBER FRAME GLASS WINDOW	TIMBER	1200 x 1500
2	102	TIMBER FRAME GLASS WINDOW	TIMBER	1200 x 1500
3	103	TIMBER FRAME GLASS WINDOW	TIMBER	1200 x 1500
4	104	TIMBER FRAME GLASS WINDOW	TIMBER	1200 x 1500
5	105	TIMBER FRAME GLASS WINDOW	TIMBER	1200 x 1500
6	106	TIMBER FRAME GLASS WINDOW	TIMBER	1200 x 1500
7	107	TIMBER FRAME GLASS WINDOW	TIMBER	1200 x 1500
8	108	TIMBER FRAME GLASS WINDOW	TIMBER	1200 x 1500
9	109	TIMBER FRAME GLASS WINDOW	TIMBER	1200 x 1500
10	110	TIMBER FRAME GLASS WINDOW	TIMBER	1200 x 1500
11	111	TIMBER FRAME GLASS WINDOW	TIMBER	1200 x 1500
12	112	TIMBER FRAME GLASS WINDOW	TIMBER	1200 x 1500
13	113	TIMBER FRAME GLASS WINDOW	TIMBER	1200 x 1500
14	114	TIMBER FRAME GLASS WINDOW	TIMBER	1200 x 1500
15	115	TIMBER FRAME GLASS WINDOW	TIMBER	1200 x 1500
16				