

NOTES

1. ALL WORK SHALL BE IN ACCORDANCE WITH THE NATIONAL BUILDING REGULATIONS 2009 AND THE NATIONAL CONSTRUCTION STANDARDS FOR BUILDINGS 2009.

2. ALL WORK SHALL BE IN ACCORDANCE WITH THE NATIONAL CONSTRUCTION STANDARDS FOR BUILDINGS 2009.

3. ALL WORK SHALL BE IN ACCORDANCE WITH THE NATIONAL CONSTRUCTION STANDARDS FOR BUILDINGS 2009.

4. ALL WORK SHALL BE IN ACCORDANCE WITH THE NATIONAL CONSTRUCTION STANDARDS FOR BUILDINGS 2009.

5. ALL WORK SHALL BE IN ACCORDANCE WITH THE NATIONAL CONSTRUCTION STANDARDS FOR BUILDINGS 2009.


6. ALL WORK SHALL BE IN ACCORDANCE WITH THE NATIONAL CONSTRUCTION STANDARDS FOR BUILDINGS 2009.

7. ALL WORK SHALL BE IN ACCORDANCE WITH THE NATIONAL CONSTRUCTION STANDARDS FOR BUILDINGS 2009.


8. ALL WORK SHALL BE IN ACCORDANCE WITH THE NATIONAL CONSTRUCTION STANDARDS FOR BUILDINGS 2009.

9. ALL WORK SHALL BE IN ACCORDANCE WITH THE NATIONAL CONSTRUCTION STANDARDS FOR BUILDINGS 2009.


10. ALL WORK SHALL BE IN ACCORDANCE WITH THE NATIONAL CONSTRUCTION STANDARDS FOR BUILDINGS 2009.

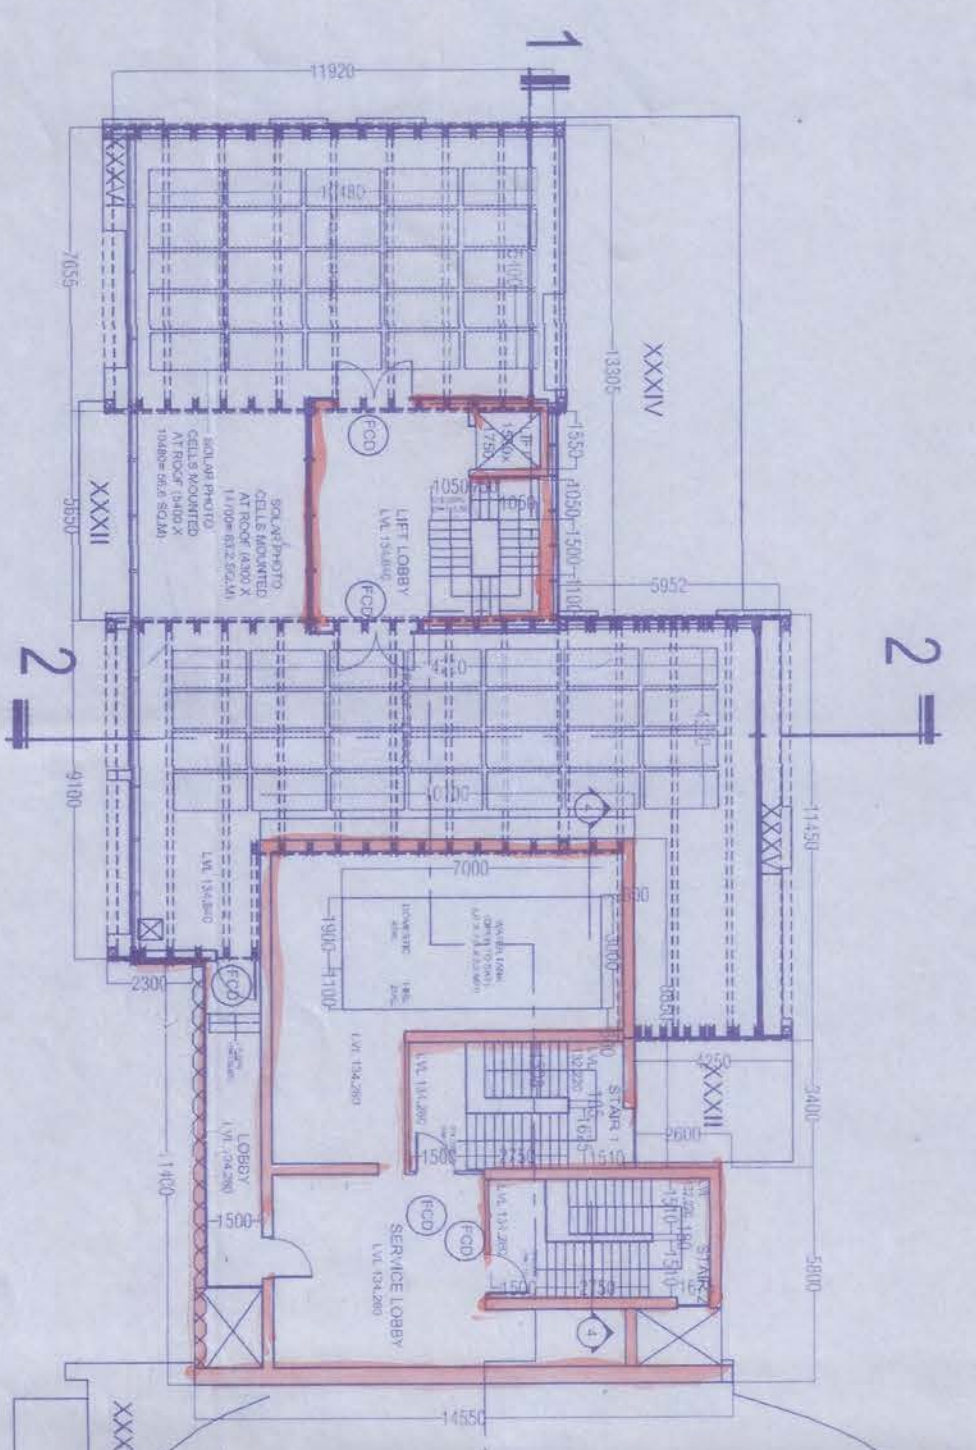


WING B - ROOF LEVEL PLAN
Scale 1:200

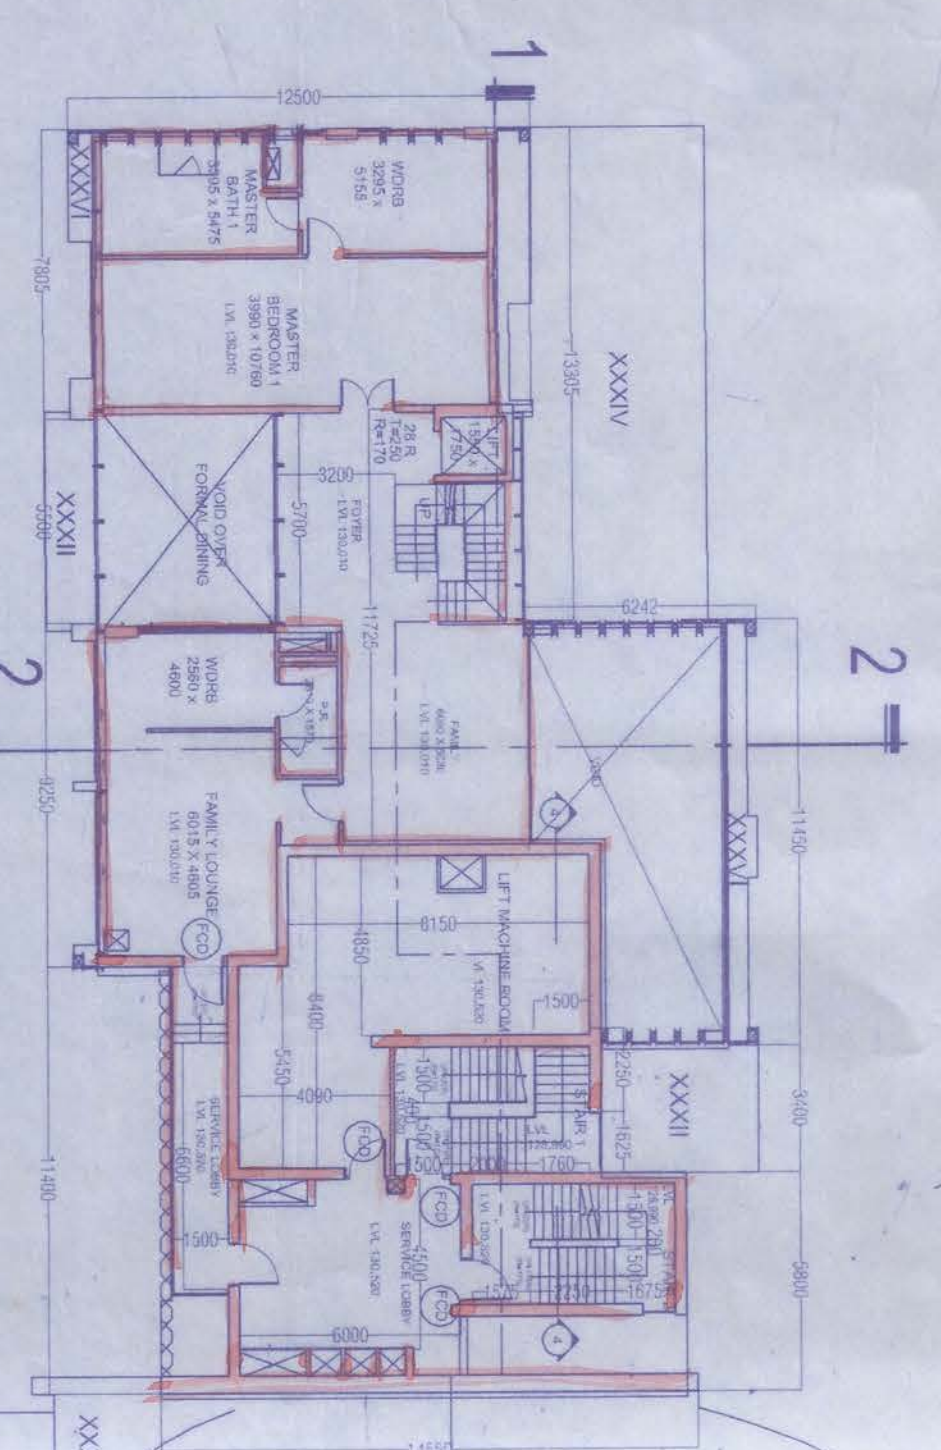


WING B - 37 TH FLOOR PLAN
Scale 1:200

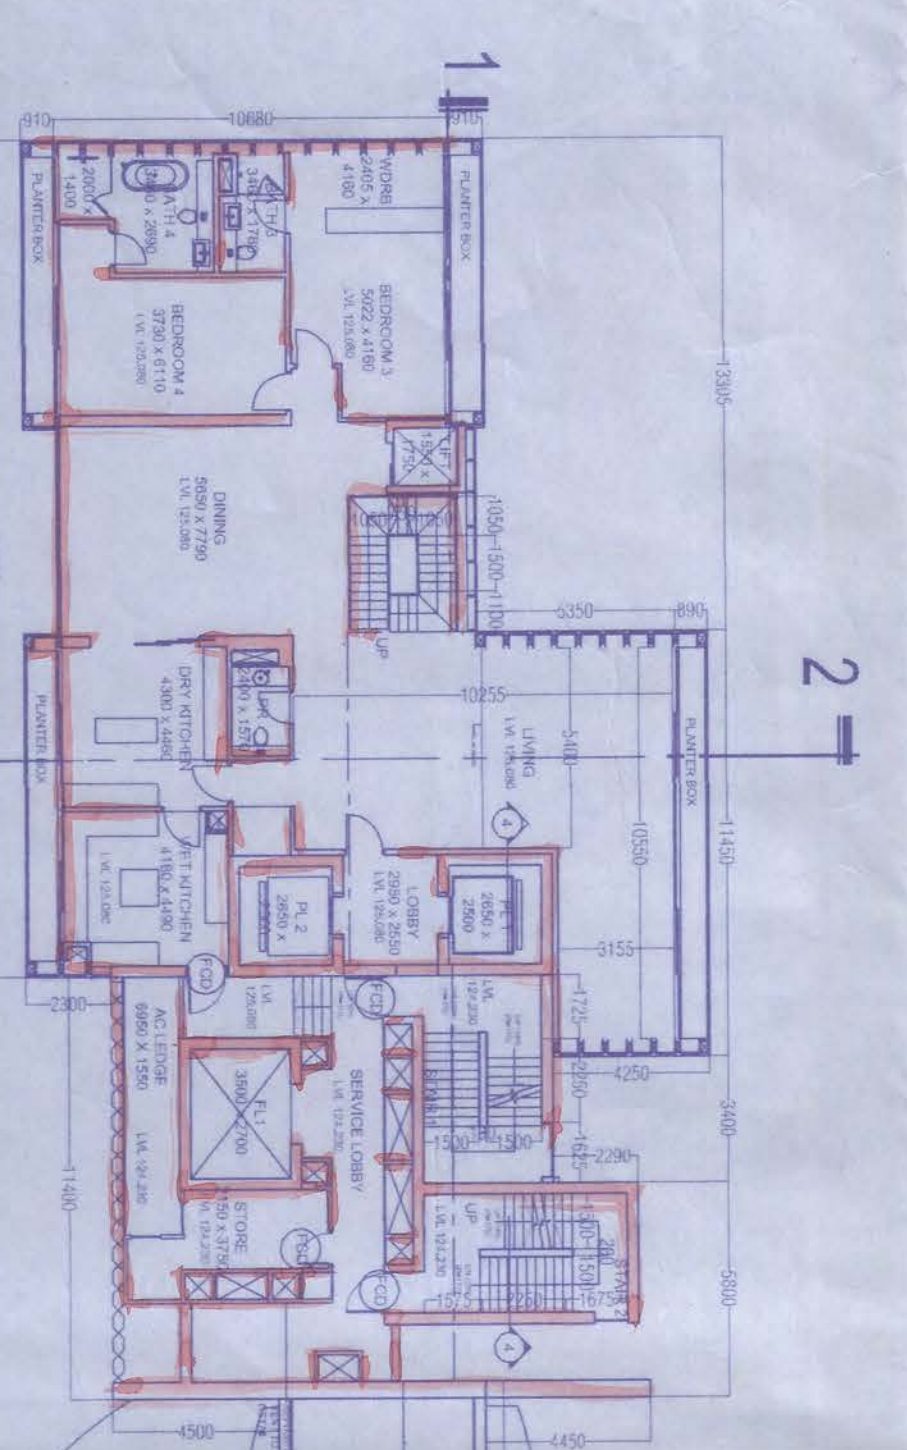


WING B - 36 FLOOR PLAN
Scale 1:200

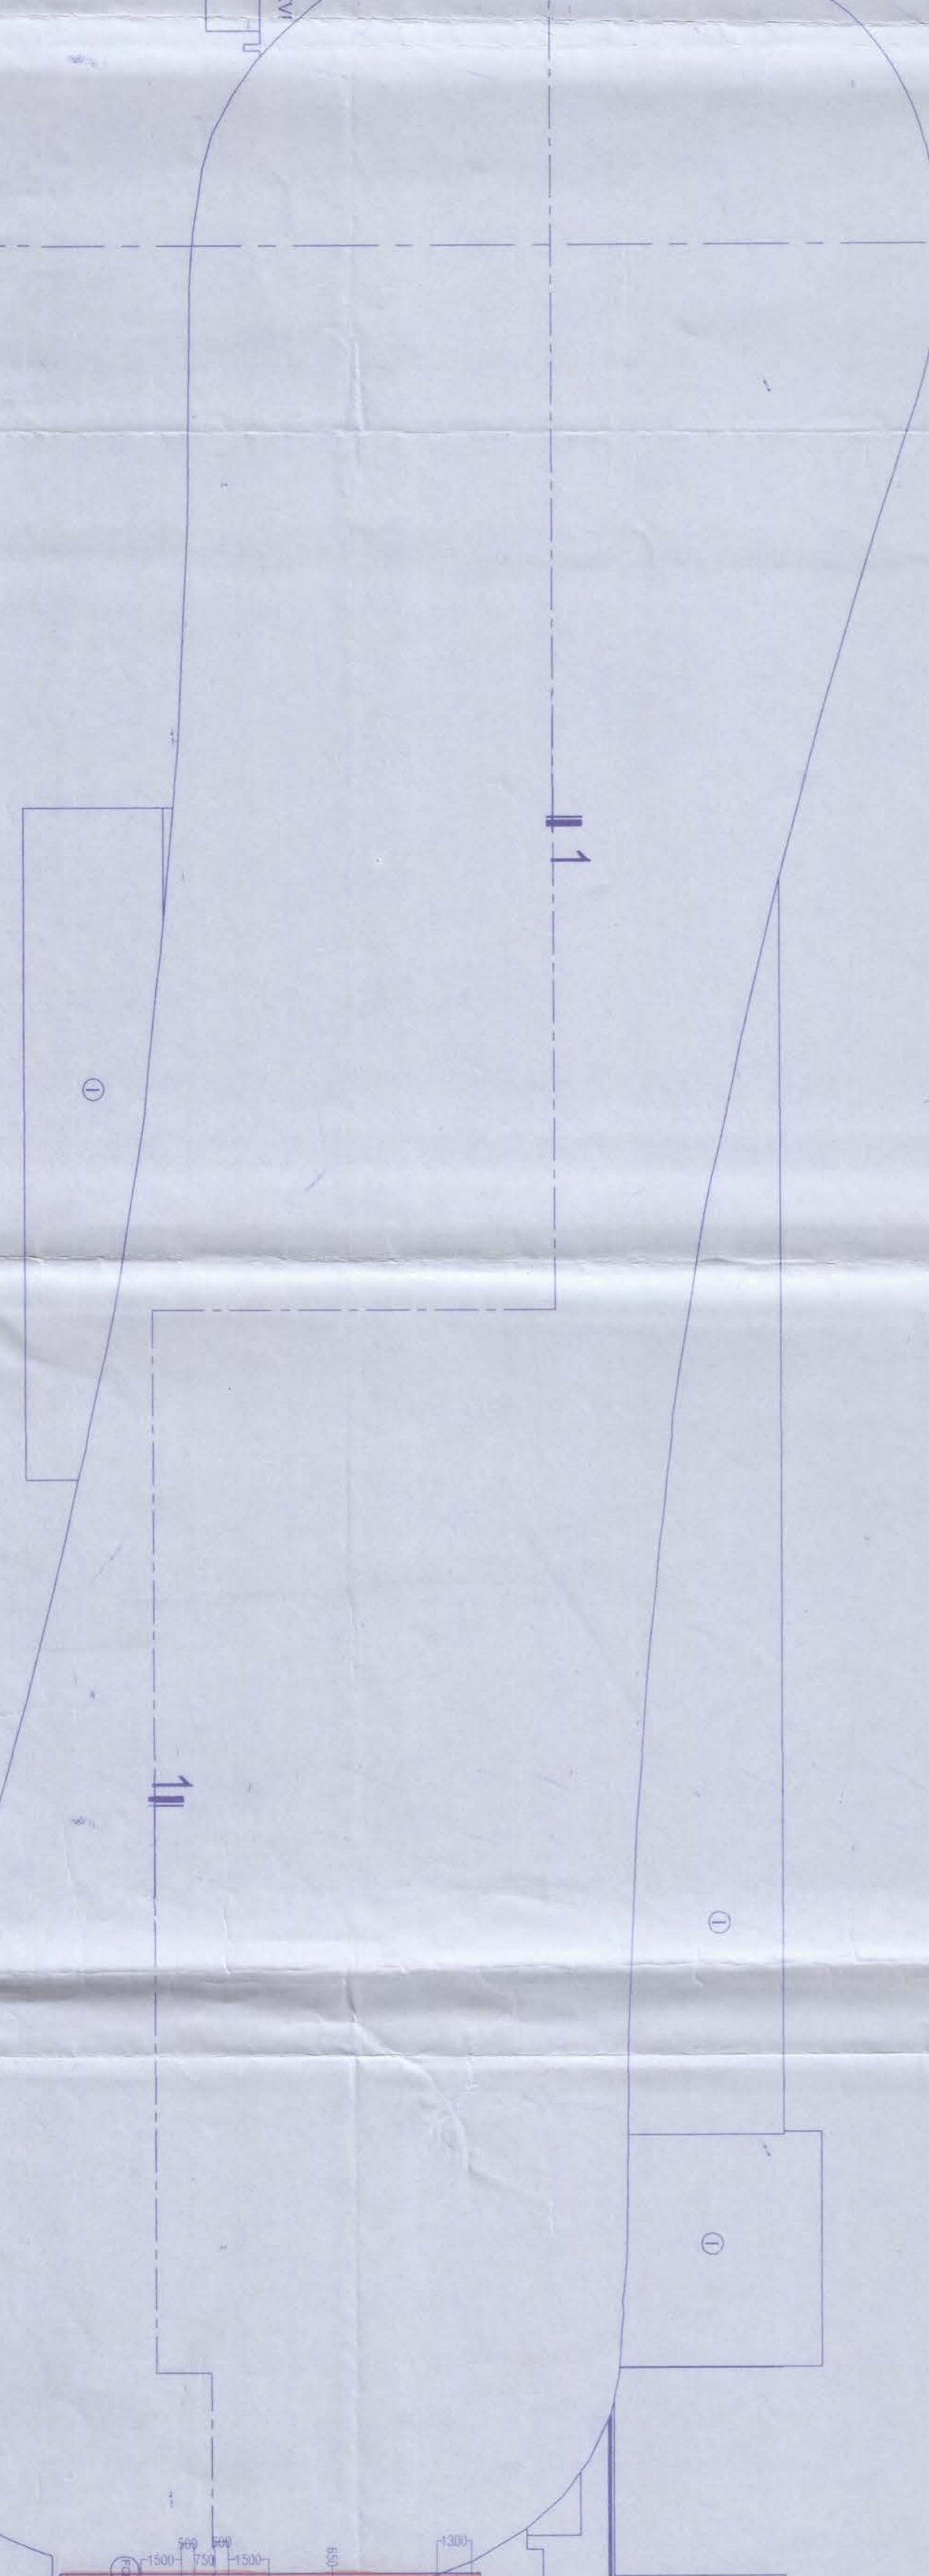


WING A - ROOF LEVEL PLAN
Scale 1:200

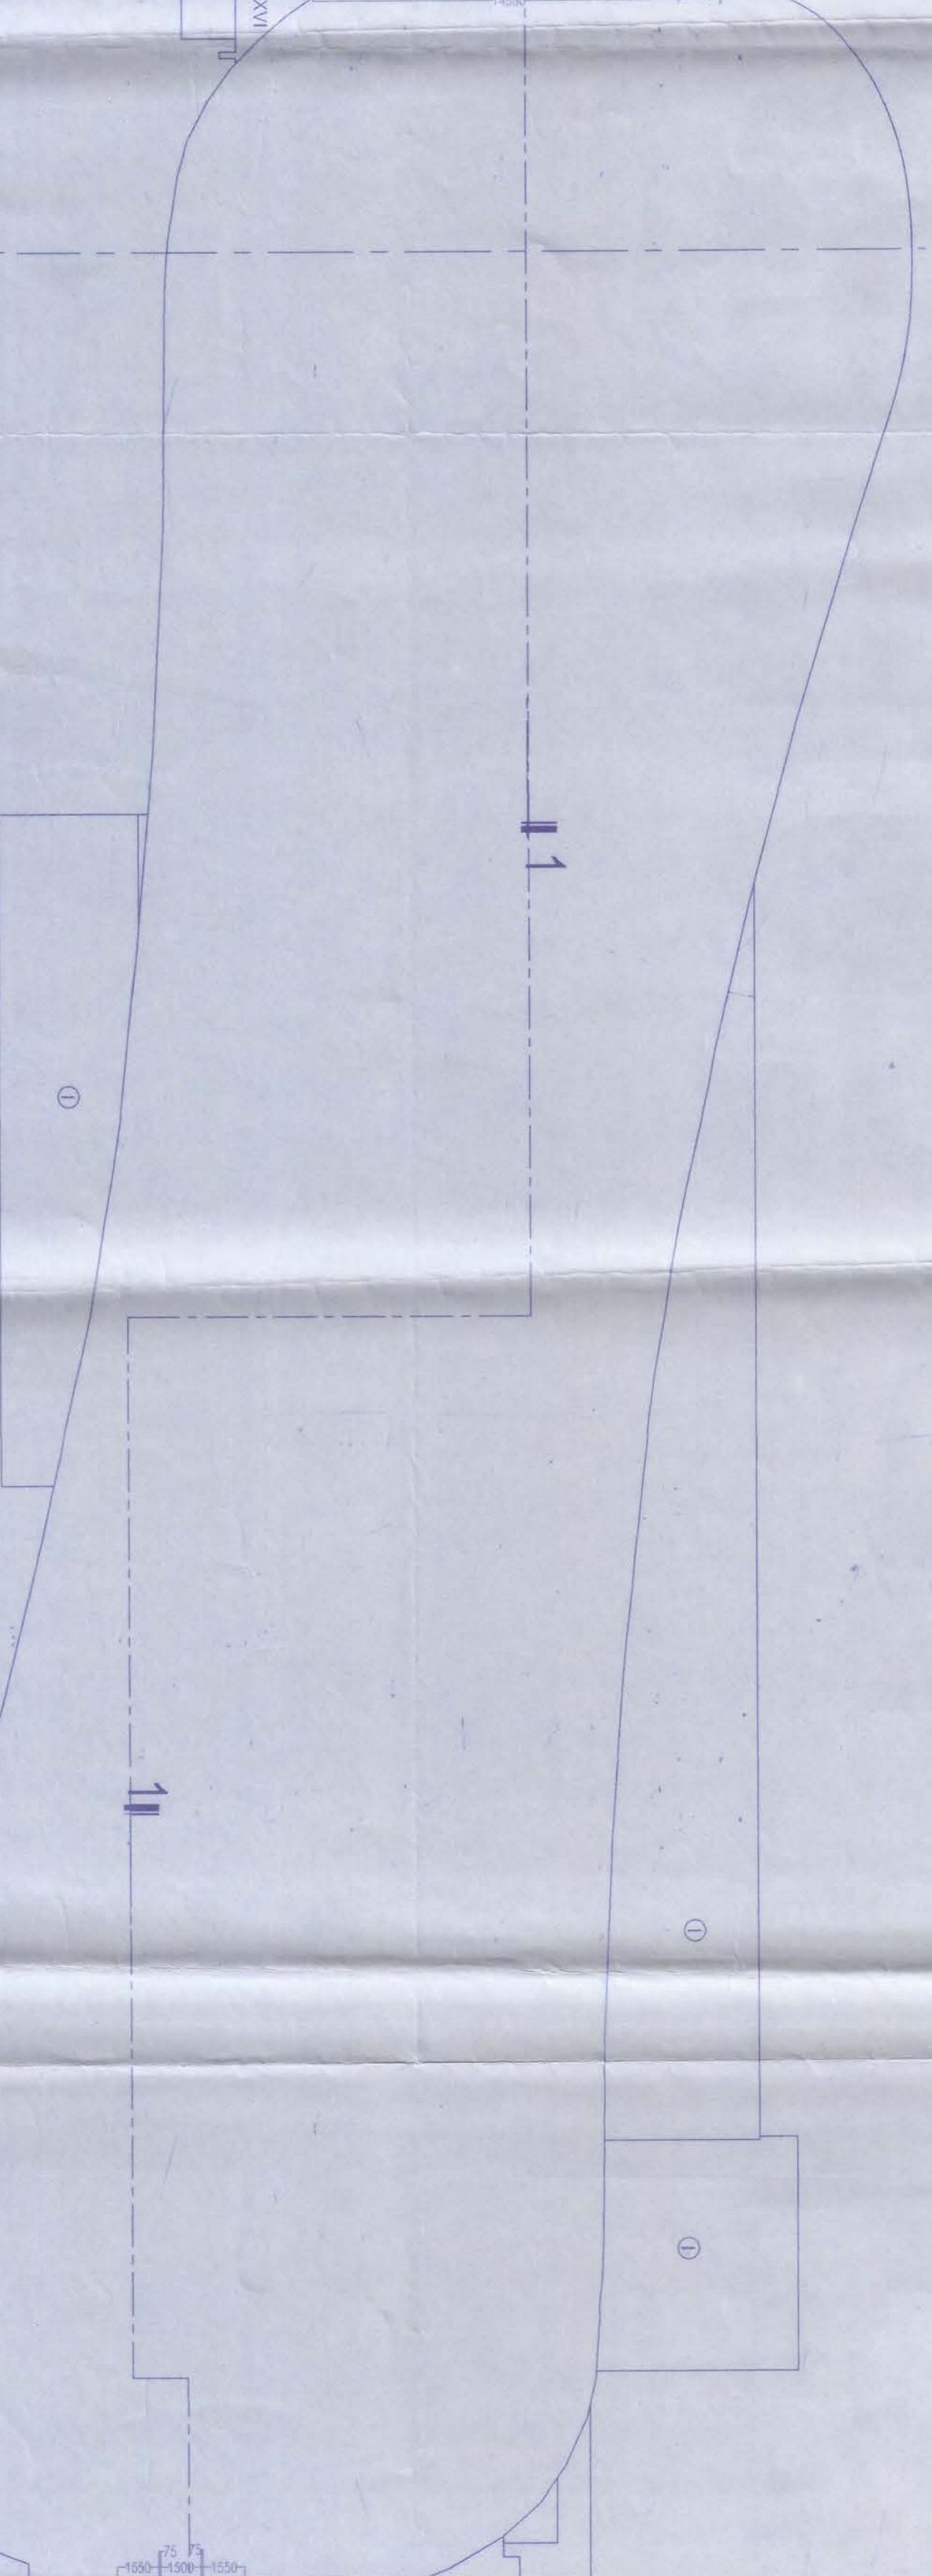


WING A - 37 TH FLOOR PLAN
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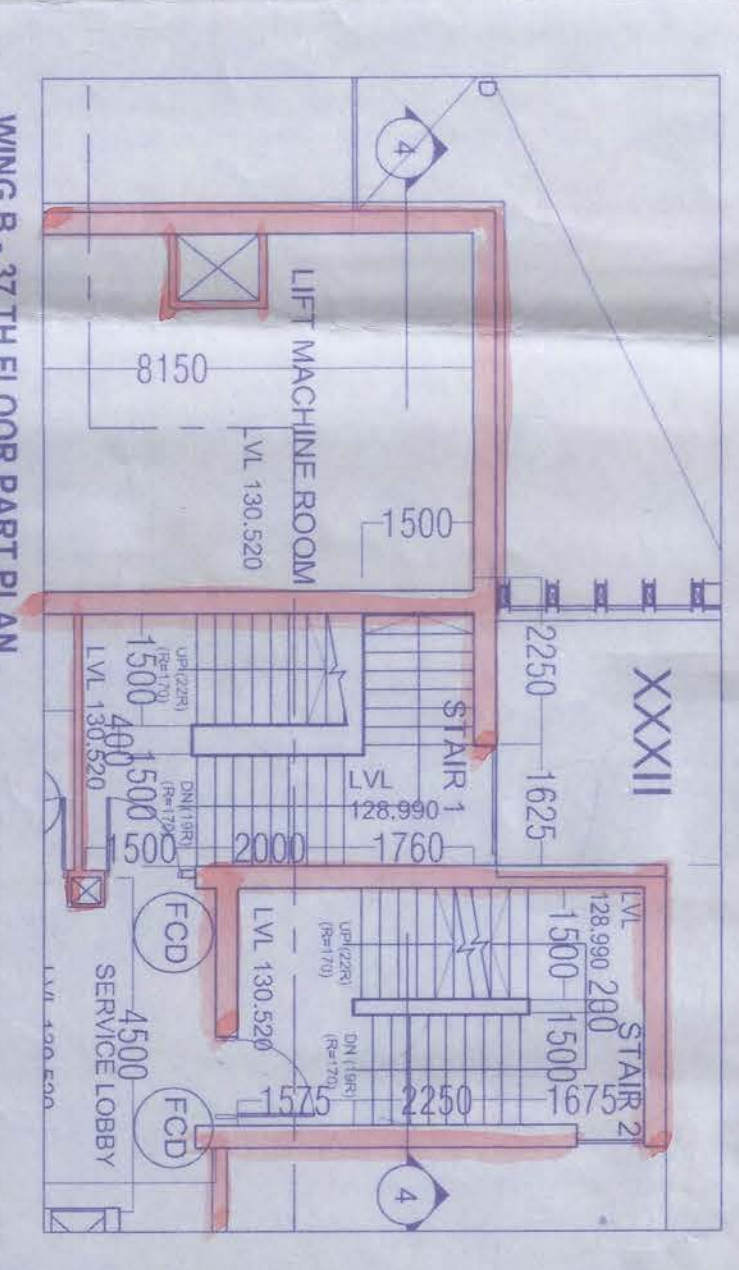
WING A - 36 FLOOR PLAN
Scale 1:200

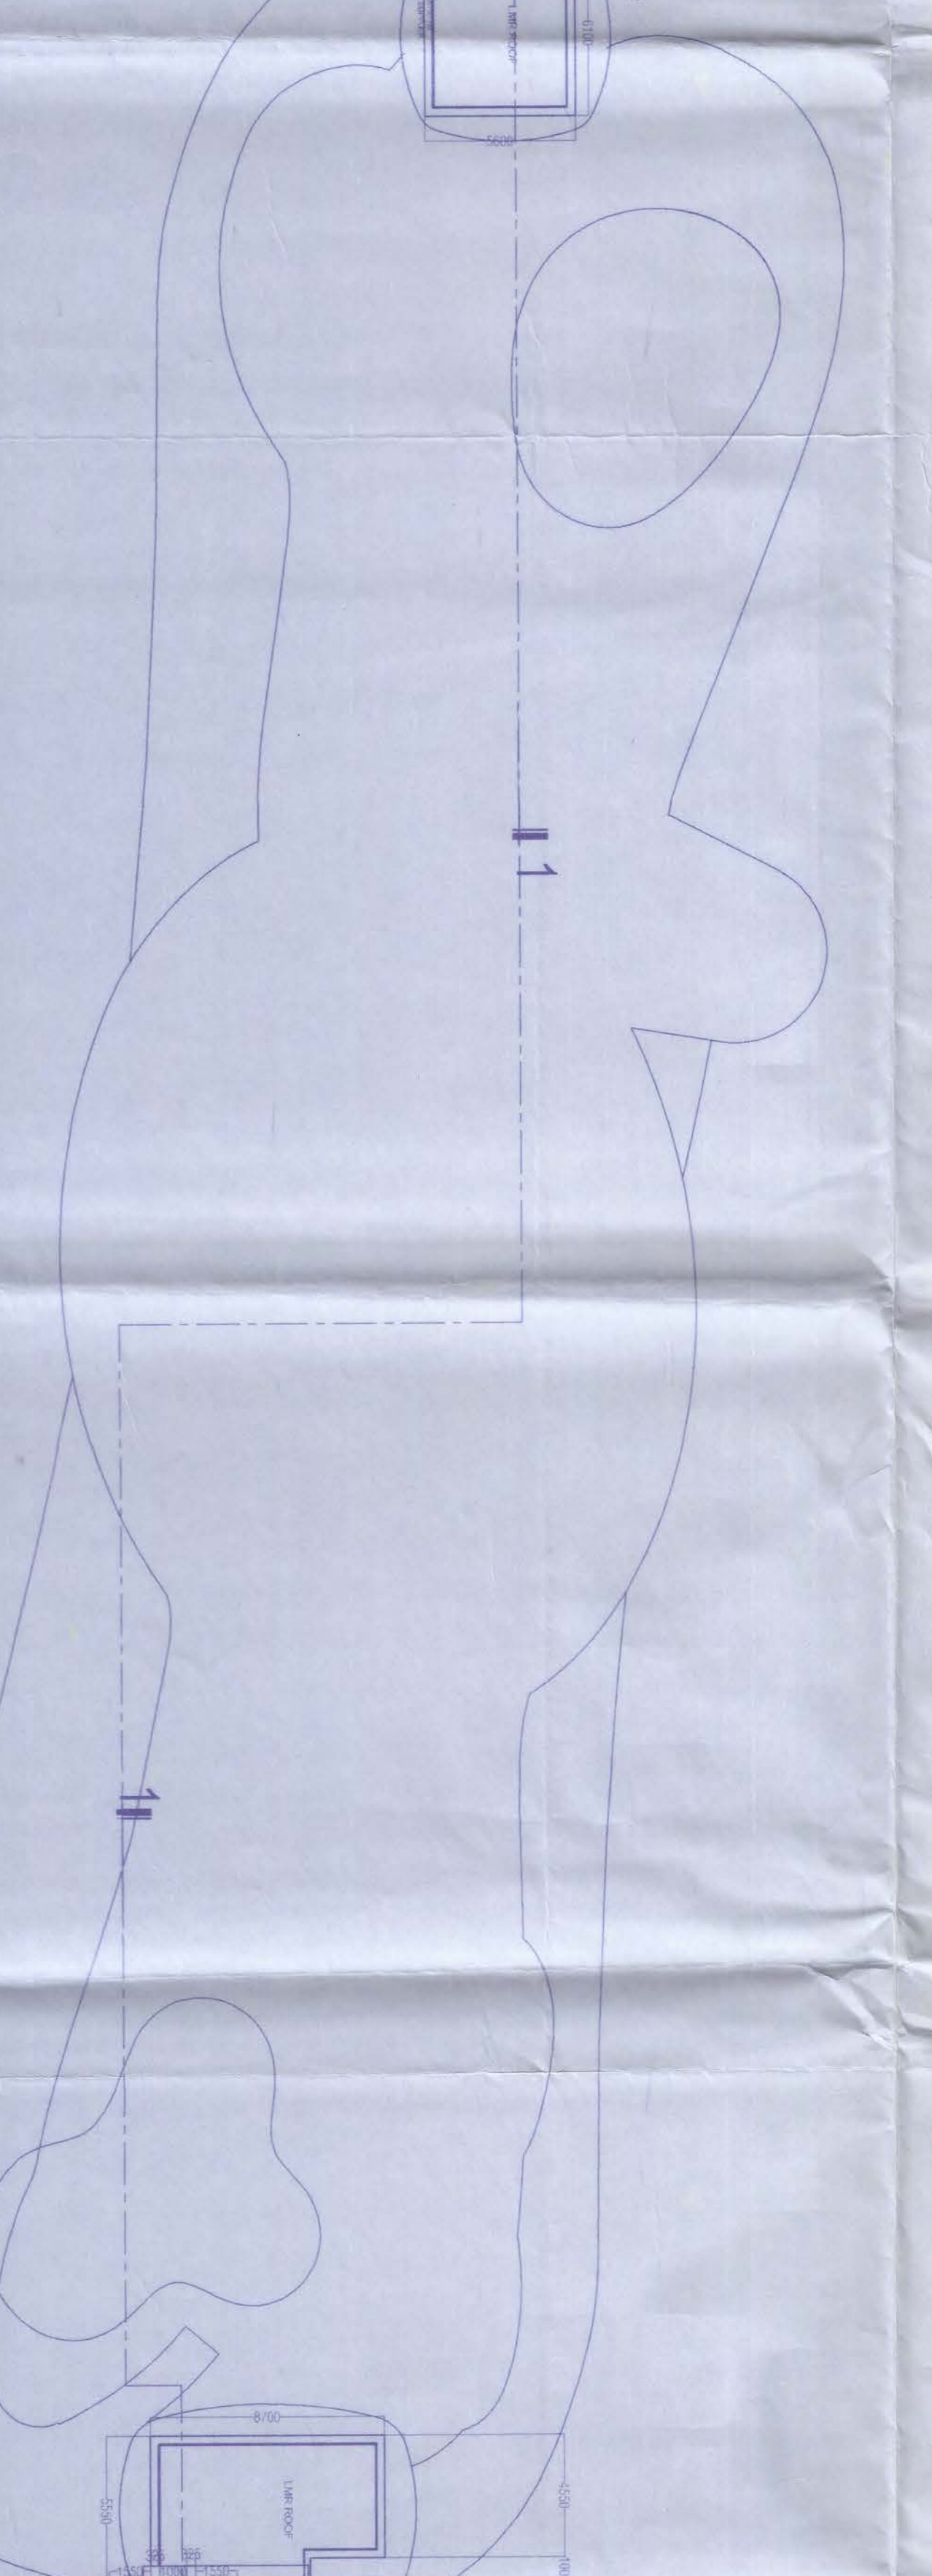


SECTION-4-4 (PART SECTION OF STAIRCASE 1)
Scale 1:100

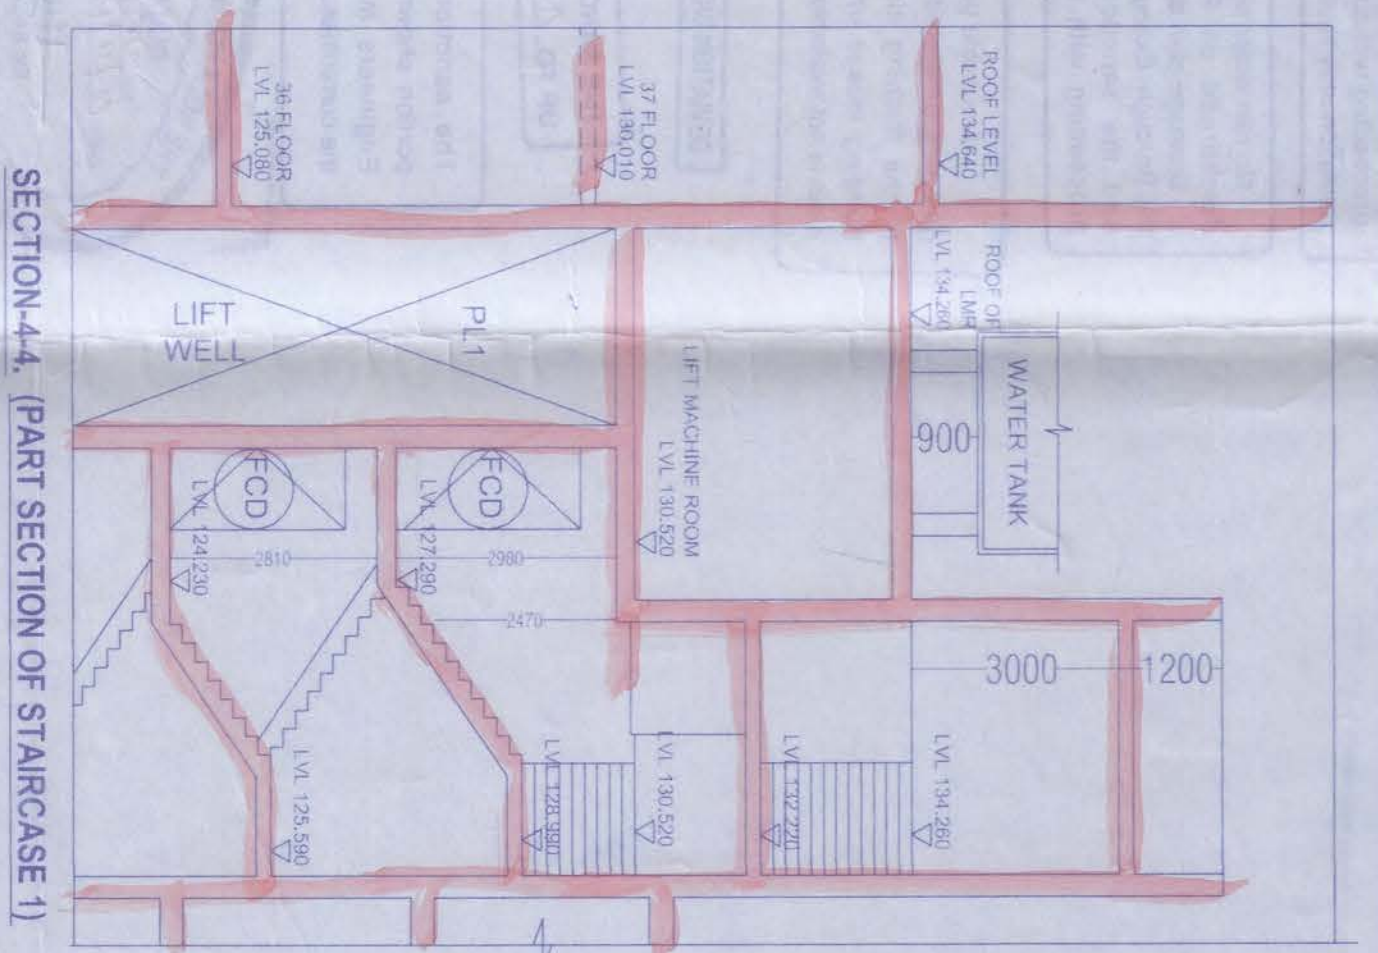


WING B - ROOF LEVEL PART PLAN
Scale 1:200

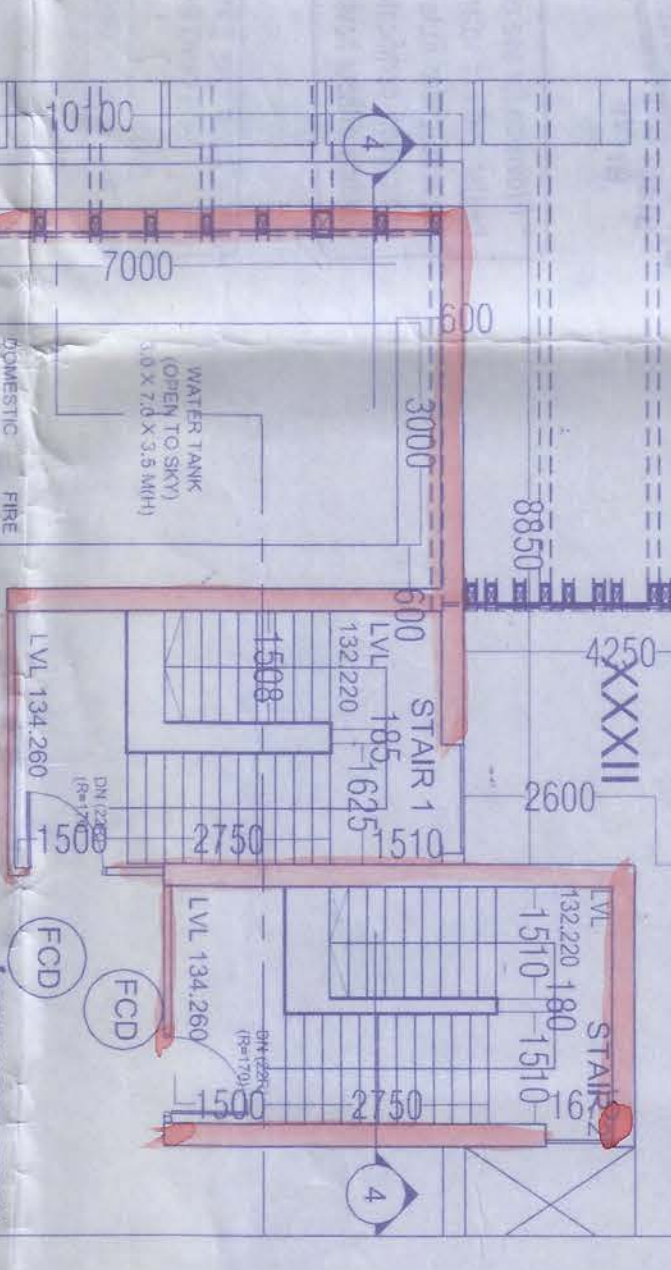

WING B - 37 TH FLOOR PART PLAN
Scale 1:200

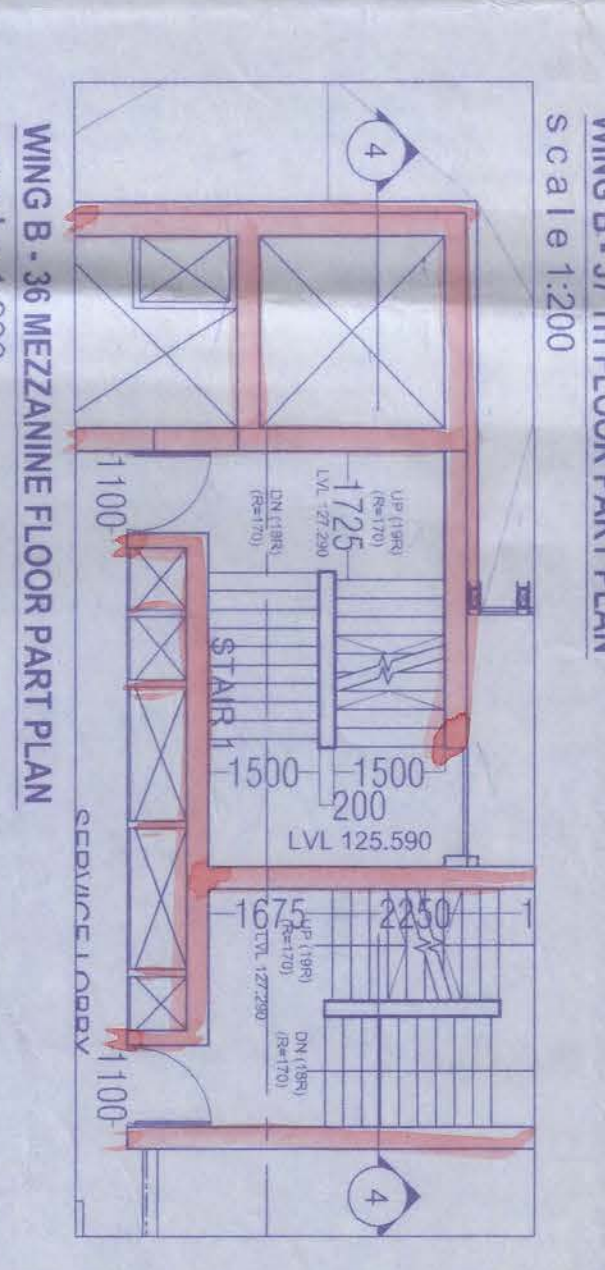

WING B - 36 MEZZANINE FLOOR PART PLAN
Scale 1:200

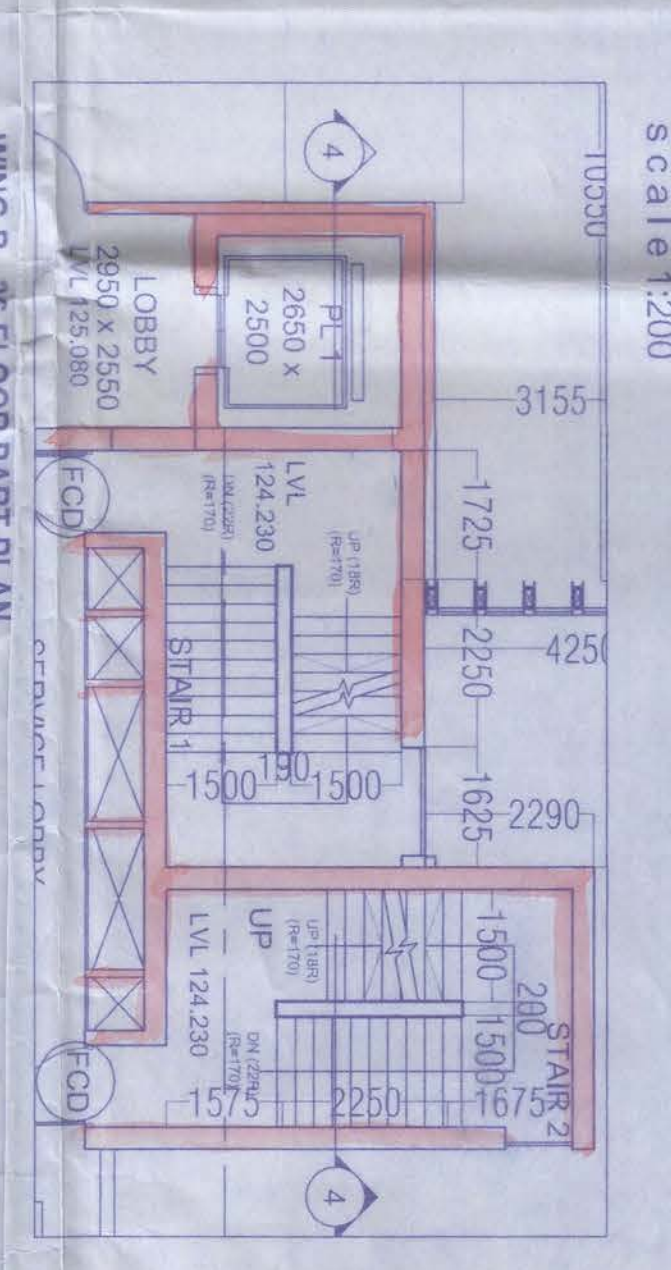

WING B - 36 FLOOR PART PLAN
Scale 1:200

SCHEDULE OF OPENING WINDOWS - ALLUMINIA

NO	TYPE	SIZE	DESCRIPTION
1	W	1500 x 1500	ALUMINIA FRAME WINDOW
2	W	1500 x 1500	ALUMINIA FRAME WINDOW
3	W	1500 x 1500	ALUMINIA FRAME WINDOW
4	W	1500 x 1500	ALUMINIA FRAME WINDOW
5	W	1500 x 1500	ALUMINIA FRAME WINDOW
6	W	1500 x 1500	ALUMINIA FRAME WINDOW
7	W	1500 x 1500	ALUMINIA FRAME WINDOW
8	W	1500 x 1500	ALUMINIA FRAME WINDOW
9	W	1500 x 1500	ALUMINIA FRAME WINDOW
10	W	1500 x 1500	ALUMINIA FRAME WINDOW
11	W	1500 x 1500	ALUMINIA FRAME WINDOW
12	W	1500 x 1500	ALUMINIA FRAME WINDOW
13	W	1500 x 1500	ALUMINIA FRAME WINDOW
14	W	1500 x 1500	ALUMINIA FRAME WINDOW
15	W	1500 x 1500	ALUMINIA FRAME WINDOW
16	W	1500 x 1500	ALUMINIA FRAME WINDOW
17	W	1500 x 1500	ALUMINIA FRAME WINDOW
18	W	1500 x 1500	ALUMINIA FRAME WINDOW
19	W	1500 x 1500	ALUMINIA FRAME WINDOW
20	W	1500 x 1500	ALUMINIA FRAME WINDOW
21	W	1500 x 1500	ALUMINIA FRAME WINDOW
22	W	1500 x 1500	ALUMINIA FRAME WINDOW
23	W	1500 x 1500	ALUMINIA FRAME WINDOW
24	W	1500 x 1500	ALUMINIA FRAME WINDOW
25	W	1500 x 1500	ALUMINIA FRAME WINDOW
26	W	1500 x 1500	ALUMINIA FRAME WINDOW
27	W	1500 x 1500	ALUMINIA FRAME WINDOW
28	W	1500 x 1500	ALUMINIA FRAME WINDOW
29	W	1500 x 1500	ALUMINIA FRAME WINDOW
30	W	1500 x 1500	ALUMINIA FRAME WINDOW

KEY PLAN
SCALE: 1:2000

CERTIFICATE OF STRUCTURAL ENGINEER

THIS IS TO CERTIFY THAT THE STRUCTURAL DESIGN AND DRAWINGS OF BOTH FOUNDATION AND SUPERSTRUCTURE HAS BEEN MADE BY ME CONSIDERING ALL POSSIBLE LOADS INCLUDING THE SEISMIC LOADS PER THE NATIONAL BUILDING REGULATIONS AND THE NATIONAL CONSTRUCTION STANDARDS FOR BUILDINGS 2009.

Mr. S. S. S. S.
LITTA S. S. S. S.
REGISTERED STRUCTURAL ENGINEER
NO. 123456789
15/10/2016

CERTIFICATE OF ARCHITECT

I DO HEREBY CERTIFY WITH FULL RESPONSIBILITY THAT THE BUILDING PLAN HAS BEEN DRAWN UP AS PER K.M.C. BUILDING RULE - 2009 AS AMENDED FROM TIME TO TIME THAT THE WIDTH OF THE ABUTTING ROAD CONFORM WITH THE PLAN AND IT IS A BUILDABLE SITE NOT A TANK OR A HATED UP WITH THE SITE. THE PLOT IS DEMARCATED BY BOUNDARY WALLS & MEASUREMENTS HAS BEEN MADE AS SHOWN FULLY OCCUPIED BY OWNERS AS PER OWNERS UNDER TAKING.

Mr. S. S. S. S.
S. S. S. S.
REGISTERED ARCHITECT
NO. 123456789
15/10/2016

FORNIN PROJECTS PVT. LTD.
4/1 RED CROSS PLACE,
KOTIKAVYA 700 001.

PROJECT: 36 TH 37 TH AND ROOF LEVEL

CLIENT: FORNIN PROJECTS PVT. LTD.
4/1 RED CROSS PLACE,
KOTIKAVYA 700 001.

DESIGNER: FORNIN PROJECTS PVT. LTD.
4/1 RED CROSS PLACE,
KOTIKAVYA 700 001.

DATE: 15/10/2016

arcstudio

PRACITICE

Practise Design Pvt. Ltd. | Technopolis | Sector 51
Saket, New Delhi 110017
91 88600 5191

RESUBMISSION TO K.M.C.

STAGE: MUNICIPAL

DIRECTION: 20 OF 26 R3

DATE: 27-JULY-16

PROJECT CODE: 16-28

PROJECT NAME: WING-A AND WING-B FLOOR PLAN

DRAWING NO: 36 TH 37 TH AND ROOF LEVEL PLAN

THE NATIONAL MUNICIPAL CORPORATION
K.M.C. BUILDING REGULATIONS 2009
K.M.C. CONSTRUCTION STANDARDS FOR BUILDINGS 2009

DR. CH. S. S. S. S.
REGISTERED ARCHITECT
NO. 123456789
15/10/2016