





APPROVED

PLAN No. CE/492/18
RB/CB/IB/P/B/UT
APN
20.03.2019
Date: 20.03.2019

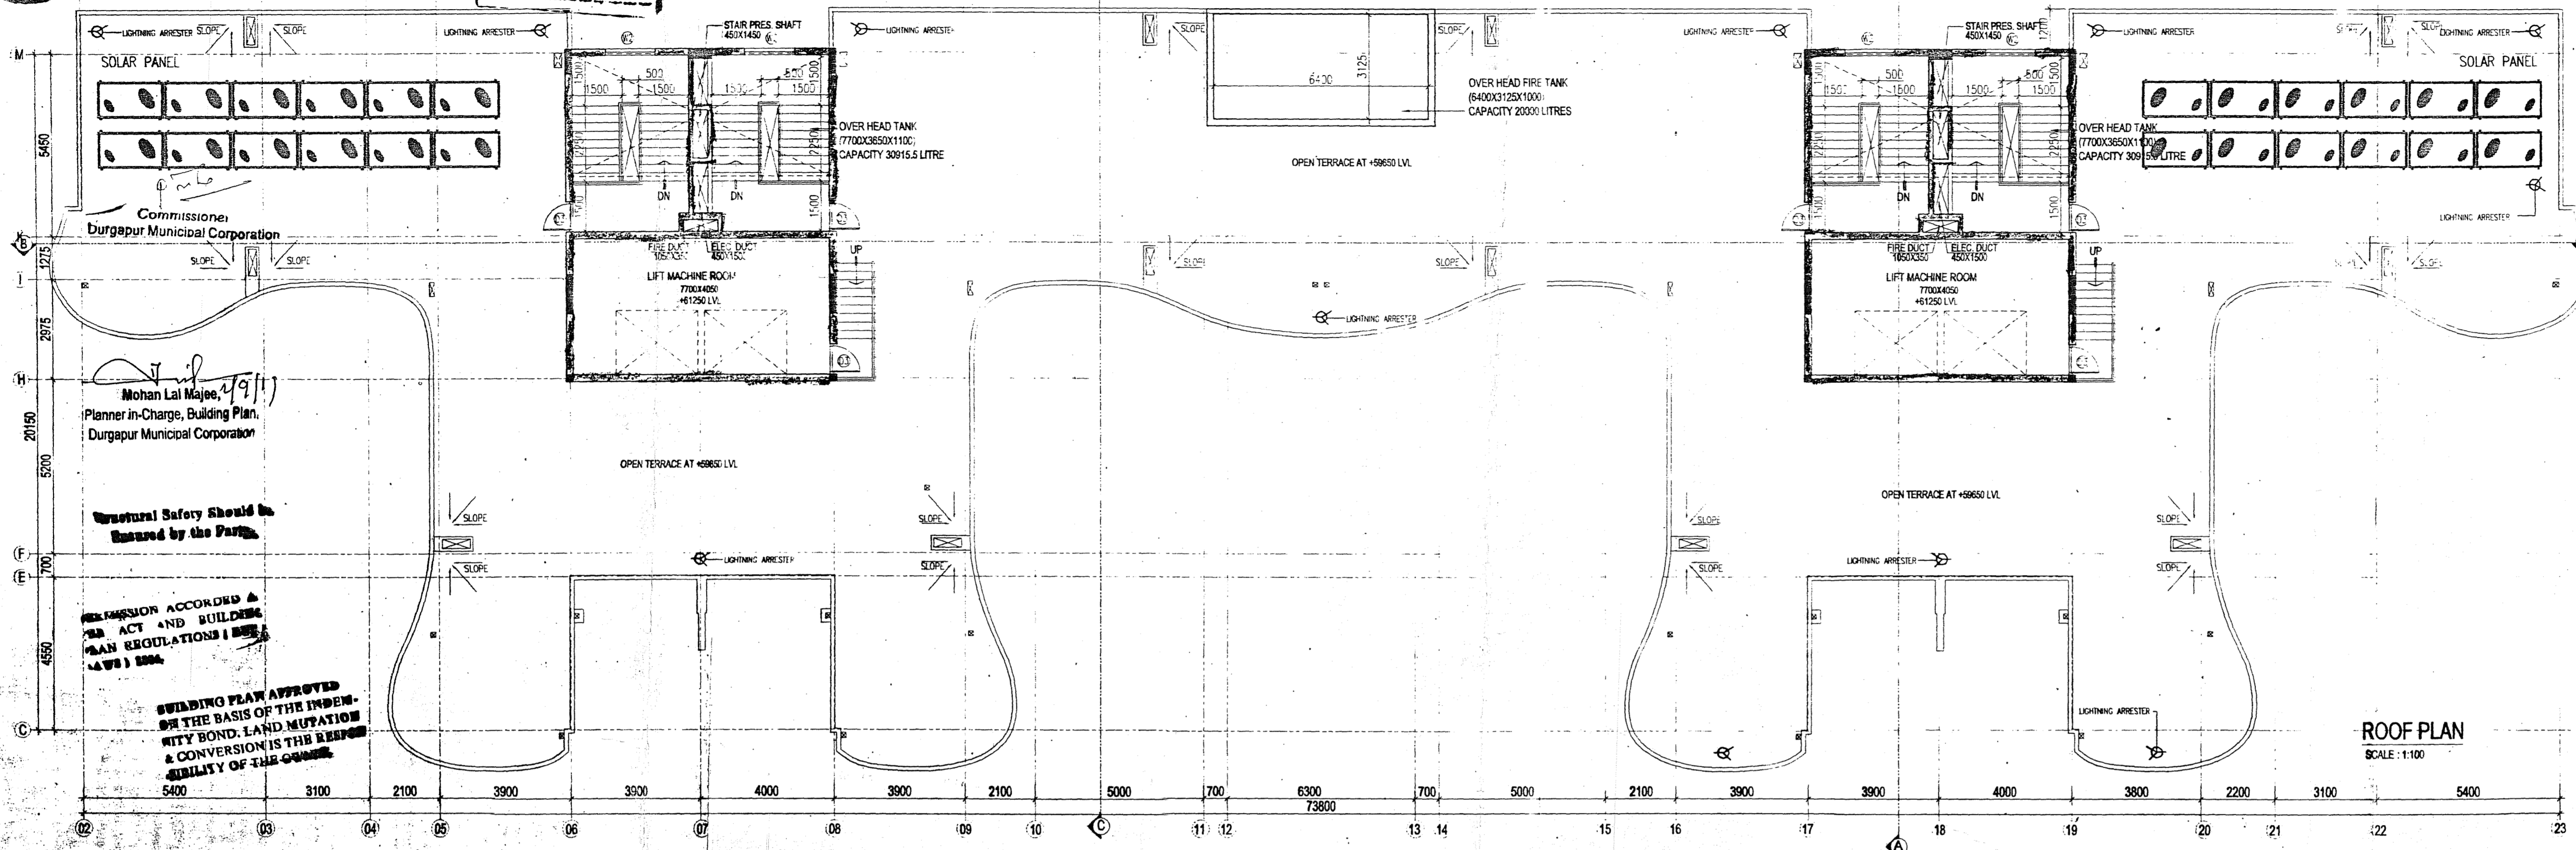

ROOF PLAN
SCALE: 1:100

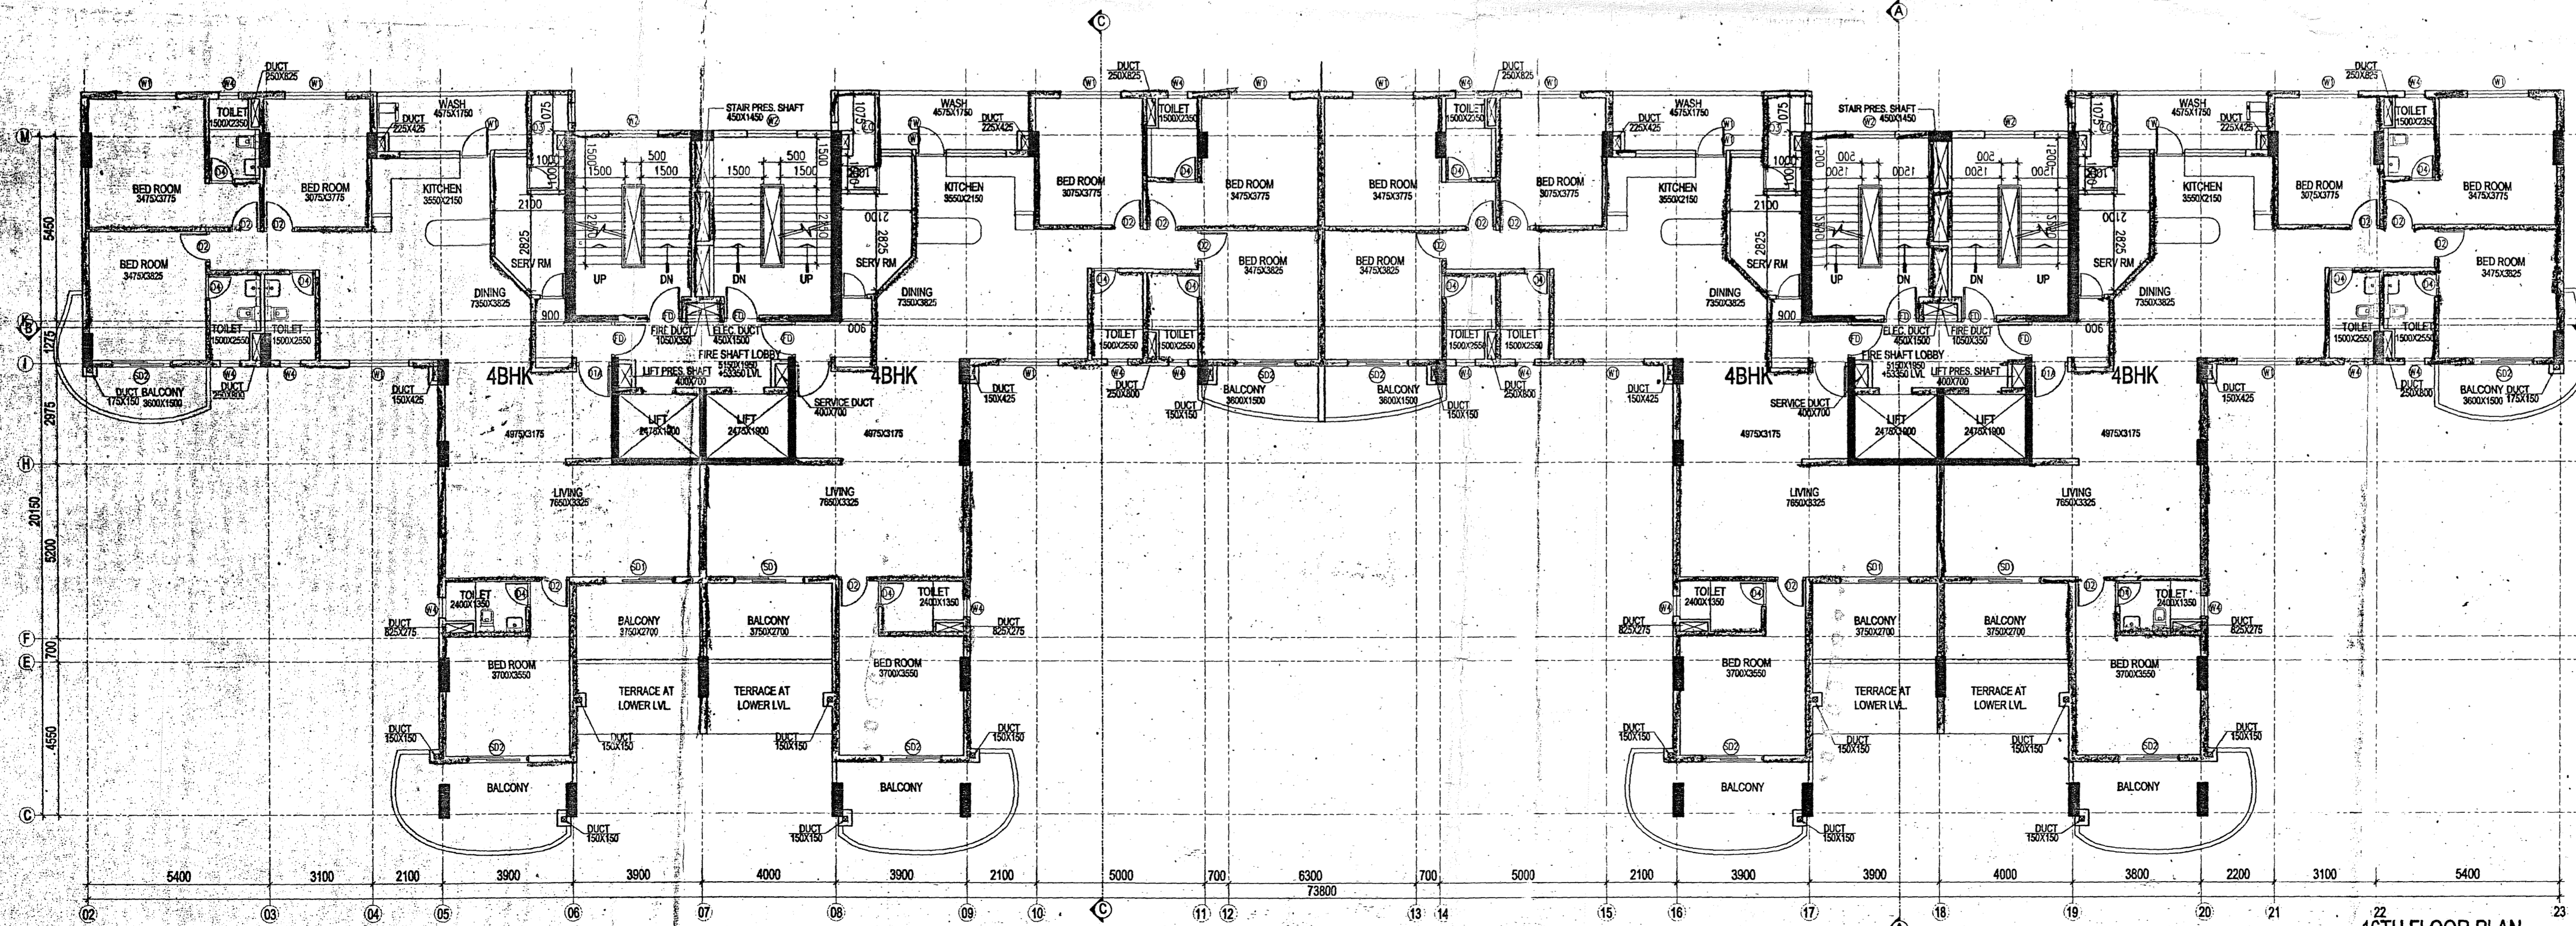

16TH FLOOR PLAN
SCALE: 1:100

NOTE:
ALL DIMENSIONS ARE IN METERS!
ALL EXTERNAL WALLS ARE 200mm THICK!
ALL INTERNAL WALLS ARE 100mm THICK!
ALL CHIMNEYS ARE 100mm THICK!

NO.	OPENING SIZE	SL. HT.	INTEL. HT.	TYPE
W1	1500X1350	750	2100	SLIDING WINDOW
W2	1500X1350	750	2100	SLIDING WINDOW
W3	900X1200	900	2100	SLIDING WINDOW
W4	600X600	1500	2100	LOUVERED WINDOW
W5	1800X450	1650	2100	SLIDING WINDOW

NO.	OPENING SIZE	INTEL. HT.	TYPE
D1	1050X2100	2100	SINGLE LEAF PANEL DOOR
D1A	1075X2100	2100	SINGLE LEAF PANEL DOOR
D2	900X2100	2100	SINGLE LEAF PANEL DOOR
D3	900X2100	2100	SINGLE LEAF PVC DOOR
D4	750X2100	2100	SINGLE LEAF PVC DOOR
D5	1000X2100	2100	SINGLE LEAF PANEL DOOR
D6	1200X2100	2100	DOUBLE LEAF PANEL DOOR
D7	750X2100	2100	SINGLE LEAF PVC DOOR
D8	1200X2100	2100	SINGLE LEAF PANEL DOOR
GD1	800X2100	2100	GLASS DOOR
GD2	1500X2100	2100	GLASS DOOR
FD	1050X2100	2100	GLASS FIRE DOOR
FD1	1050X2100	2100	FIRE DOOR
SD1	2100X2400	2400	ALUMINIUM SLIDING DOOR
SD2	1800X2400	2400	ALUMINIUM SLIDING DOOR

CERTIFICATE BY THE OWNER
 CERTIFIED THAT I HAVE GONE THROUGH THE BUILDING RULES FOR DURGAPUR AND ALSO UNDERTAKE TO ABIDE BY THOSE RULES DURING AND AFTER THE CONSTRUCTION OF THE BUILDING.
 CERTIFIED THAT I SHALL NOT ON A LATER DATE MAKE ANY ADDITION AND ALTERATION TO THIS PLAN.
 DUTTA AUTOMOBILES
 Kamlesh Dutta
 SIGNATURE OF OWNER

CERTIFICATE BY STRUCTURAL ENGINEER
 CERTIFIED THAT THE STRUCTURAL DRAWING AND DESIGN & DRAWINGS FOR BOTH THE FOUNDATION & SUPER STRUCTURE OF THE BUILDING HAVE BEEN MADE BY ME CONSIDERING THE SOIL TEST REPORT AND ALSO CONSIDERING ALL POSSIBLE LOADS, SEISMIC LOAD AND THE MOMENTS GENERATED BY THE PROPOSED STRUCTURES AS PER THE BUREAU OF INDIAN STANDARD AND THE NATIONAL BUILDING CODE OF INDIA & CERTIFIED THAT IT IS SAFE & STABLE IN ALL RESPECT & THESE PROVISIONS SHALL BE ADHERED TO DURING THE CONSTRUCTION.
 SANJIV J. PAREKH
 M.E. (STRUCTURAL), M.E. (CONST. ENG.),
 W.C.E., FIE (E-418392-4)
 E.S.E. NO. 104 (I) K. M. C.
 SIGNATURE OF STRUCTURAL ENGINEER

CERTIFICATE BY GEO TECHNICAL ENGINEER
 CERTIFIED THAT THE FOUNDATION AND SUPERSTRUCTURE OF THE BUILDING PROPOSED FOR CONSTRUCTION HAVE BEEN PERSONALLY INSPECTED & SOIL CONDITION HAS BEEN CHECKED BY ME THAT WILL MAKE SUCH FOUNDATION AND SUPERSTRUCTURE SAFE IN ALL RESPECT INCLUDING THE CONSIDERATION OF BEARING CAPACITY AND SETTLEMENT OF SOIL AND OTHER CONDITIONS, IF ANY, CONFORMING TO ALL SPECIFICATIONS OF ALL RELEVANT IS CODE OF PRACTICE AND NATIONAL BUILDING CODE.
 SIGNATURE OF GEO TECHNICAL ENGINEER

CERTIFICATE BY ARCHITECT
 CERTIFIED THAT THE PLAN HAS BEEN DESIGNED AND DRAWN UP STRICTLY ACCORDING TO THE BUILDING RULES OF DURGAPUR. CERTIFIED THAT THE FOUNDATION AND SUPERSTRUCTURE OF THE BUILDING HAS BEEN SO DESIGNED BY ME AS TO BE SAFE IN ALL RESPECT INCLUDING THE CONSIDERATION OF SAFE BEARING CAPACITY AND SETTLEMENT OF SOIL.
 R. BHATTACHARYA
 13/03/19
 REGISTERED ARCHITECT
 Council of Architects & Surveyors
 Regn. No. CA/92/19224
 SIGNATURE OF ARCHITECT

PROJECT :
 PROPOSED B1+B2+G+16 STORED RESIDENTIAL CUM PARTLY COMMERCIAL BUILDING OF 'DUTTA AUTOMOBILES' AT MOUZA - FARIDPUR, J.L. NO. P.S. - DURGAPUR, DIST - PASCHIM BARDHAMAN, LAYOUT PLAN NO. - C2/1 & C2/1A, C.S. PLOT NO. - 856(P), 854(P), 3030(P), KHATAN NO. - 1362, SUB REG. OFFICER, CITY CENTRE, DURGAPUR - 16
 HOLDING NO. 334/N, ASSESSMENT NO. 3309401403945
 WARD NO. 32, STREET RD 100, PALASDIHA, DURGAPUR

CONTENT :
 16TH FLOOR PLAN & ROOF PLAN

CLIENT :
 DUTTA AUTOMOBILES,
 NACHAN ROAD, DURGAPUR

Architects :
 SBA SPECTRA CONSULTANTS
 Architects, Planners, Engineers, Valuers.
 DA - 170, Salt Lake, Kolkata - 700 064.

SCALE	AS SHOWN	REVISION	DRG. NO.
DATE	02.03.2019		
DEALT			
CHRD.			

DBD/ARCH-06