



Scanned by CamScanner

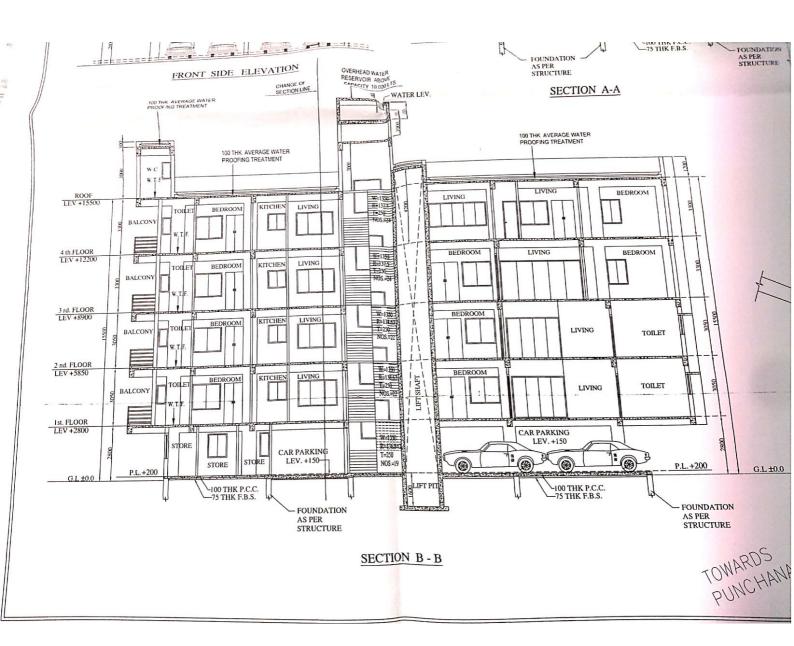

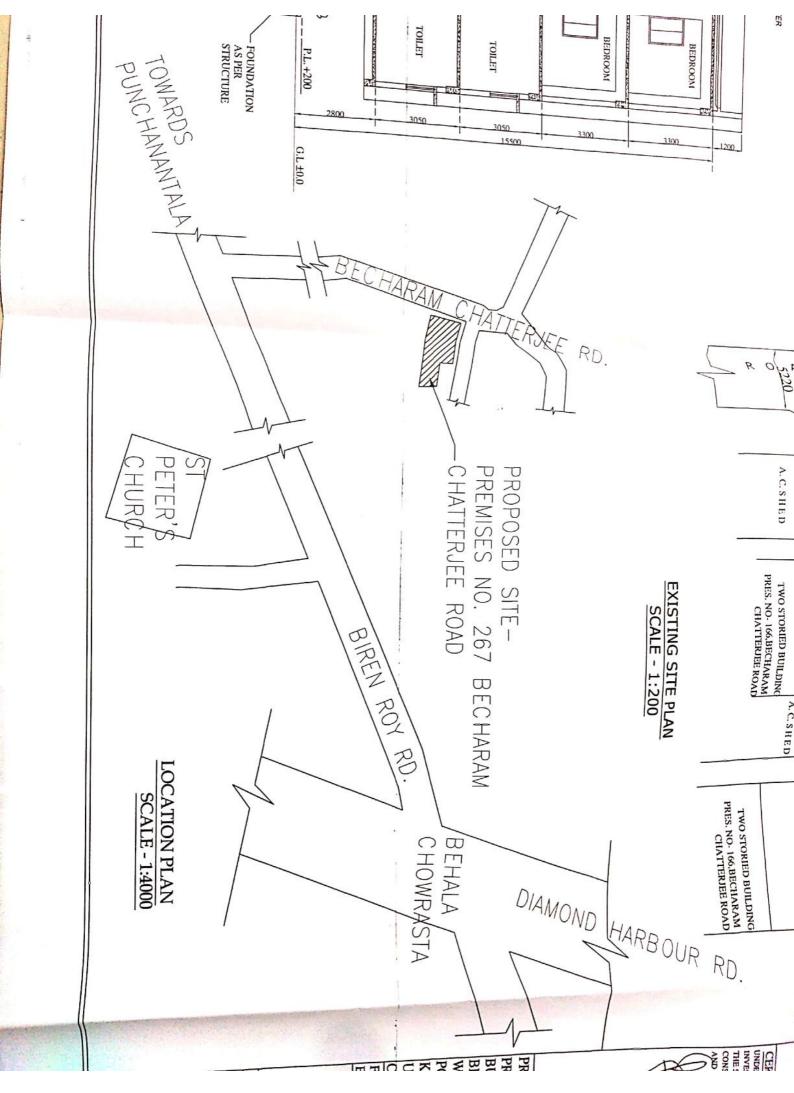

Scanned by CamScanner

#### **SPECIFICATIONS**

- 1. ALL GRADE OF CONCRETE M25.
- 2. ALL GRADE OF STEEL Fe 500
- 3. ALL OUTER WALL 200 mm THK. 1:6 MORTER.
- 4. ALL INTERNAL WALL-100 mm THK WITH 1:4 MORTER EXCEPT OTHERWISE MENTIONED.
- 5. ALL PLASTER 15mm THK WITH 1:4 MORTER.
- 6. BEARING CAPACITY OF SOIL AS PER SOIL REPORT.
- 7. ALL DIMENSIONS ARE IN MM.

#### CERTIFICATE OF OWNER(S)

WE DO HEREBY DECLARE WITH FULL RESPONSIBILITY THAT WE SHALL ENGAGE ARCHITECH AND E.S.E. DURING CONSTRUCTION. WE SHALL FOLLOW THAT INSTRUCTION OF ARCHITECH AND E.S.E. DURING CONSTRUCTION OF BUILDING (AS PER B.S. PLAN). K.M.C. AUTHORITY WILL NOT BE RESPONSIBLE FOR STRUCTURAL STABILITY OF THE BUILDING AND ADJOINING STRUCTURES. THE PLOT IS IDENTIFIED BY ME AND IF ANY SUBMITTED DOCUMENTS ARE FOUND TO BE FAKE, THE K.M.C. AUTHORITY WILL REVOKE THE SANCTION PLAN.

Surpeau lautituite

SIGNATURE OF OWNER(S)
MUKUL MITTRA & SWAPAN KANTI MITRA

#### CERTIFICATE OF ARCHITECT

CERTIFIED WITH FULL RESPONSIBILITY THAT THE BUILDING PLAN HAS BEEN DRAWN UP AS PER PROVISION OF K.M.C. BUILDING RULES -2009 AS AMENED FROM TIME TO TIME & THAT THE SITE CONDITION INCLUDING THE WIDTH OF THE ABUTTING 6.170 M. ROAD MAINTAINED BY K.M.C. CONFIRM WITH THE PLAN, WHICH HAS BEEN MEASURED AND VERIFIED BY ME. IT IS A BUILDABLE SITE & NOT A TANK OR FILLED - UP TANK. THERE IS AN EXISTING STRUCTURE TO BE DEMOLISHED BEFORE COMMENCEMENT WHICH IS FULLY OCCUPIED BY THE OWNER. THE PLOT IS BOUNDED BY BOUNDARY WALLS.THE CONSTRUCTION OF U.G. WATER TANK AND SEPTIC TANK WILL BE COMPLETED BEFORE STARTING OF BUILDING FOUNDATION WORK.

SAUGAFA MITTRA BARCH.. ANA

CAY 2002/29849

SIGNATURE OF ARCHITECT SAUGATA MITTRA B.ARCH, AIIA REG. NO.- CA/2002/29849

### CERTIFICATE OF STRUCTURAL STABILITY

THE STRUCTURE DESIGN OF BOTH FOUNDATION AND SUPERSTRUCTURE OF THE BUILDING HAVE BEEN MADE BY ME CONSIDERING ALL POSSIBLE LOAD INCLUDING THE SEISMIC LOAD AS PER N.B.C OF INDIA AND BASIS OF SOIL INVESTIGATION REPORT BY "TECHNOMA (I)" 37B, HINDUSTHAN ROAD, KOL-29. CERTIFY THAT IT IS SAFE AND STABLE IN ALL RESPECT.

Soma Kazi

E.S.E. - I - 221

Kolkata Municipal Corporation

SIGNATURE OF STRUCTURAL ENGINEER SOMA KAZI

58 F, Hindusthan Park, KOLKATA-700 029 EMPANELMENT NO.- ESE-I/221

# CERTIFICATE OF GEO - TECHNICAL ENGINEER

UNDERSIGNED HAS INSPECTED THE SITE AND CARRIED OUT SOIL INVESTIGATION THEREON. IT IS CERTIFIED THAT THE EXISTING SOIL OF THE SITE IS ABLE TO CARRY THE LOAD COMING FROM THE PROPOSED CONSTRUCTION AND THE FOUNDATION SYSTEM HEREIN IS SAFE AND STABLE IN ALL RESPECT FROM GEO-TECHNICAL POINT OF VIEW.

J.N. GHUE

ME (Geo-technical Englished BCE, Chartered Engines. Fellow (I.E.I.). F.I.V.

Consulting Engineer & Value

(G.T/1/4)

SIGNATURE OF GEO-TECHNICAL ENGINEER
J.N. GHOSH
TECHNOMA (I)
37B, HINDUSTHAN ROAD
KOLKATA - 700029
EMPANELMENT NO. - G.T/I/4

## PROJECT TITLE:

PROPOSED G+IV (HT.-15.5M) RESIDENTIAL BUILDING AT PREMISES NO.- 267, BECHARAM CHATTERJEE ROAD, WARD NO.- 128, BOROUGH NO. - XIV, POLICE STATION - PARNASREE, KOLKATA- 700061 DIST.- 24 PGS.(SOUTH). UNDER THE KOLKATA MUNICIPAL

CORPORATION:

FRONT ELEVATION, SECTION A-A, SECTION B-B, EXISTING SITE PLAN, LOCATION PLAN

### PROJECT ARCHITECT:-



# CONSULTANTS FOR HUMAN SETTLEMENT

FLAT-38, 7TH FLoor, 105 Park Street, Kolkata-700016 Tel.:+91-33-22651263/64,

E- mail : saugata.shelter@gmail.com

164/B Becharam Chatterjee Street, Kolkata-700061


566 Anna Salai, Teynapet, Chennai- 600018

**DEALT BY: LAKSHMIPRIYA** 

SCALE: 1:100

DATE: 23.05.2019

DWG NO: 267 BCR/KMC/AR/03

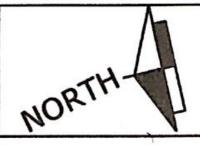

# SPACE FOR OFFICE USE

FRONT ELEVATION SECTION A-A SECTION B-B EXISTING SITE PLAT

LOCATION PLAN

## PARTY'S COP

DEVIATION WOULD MEAN DEMOLITION

AL BUILDING CONSTRUCTION SITE SHALL BE MAINTAINED TO PREVENT MOSQUITO BREEDING AS REQUIRED U/S 496(1) & (2) OF CMC ACT1980, IN SUCH MANNER SO THAT ALL WATER COLLECTIONS PARTICULABLY LIFE WELLS, VATS, BASEMENT SURING SITES OPEN RECEPTACLES ETO AS EMPITED COMPLETELY TWICE & WEAR"

No rain water pipe should be fixed or discharged on Road or Footpath. Drainage plan should be submitted at the Borough Formula Engineer's Office and the sauction obtained before proceeding with the diamage work

Before starting any Construction the site most conform with plans sanctioned and all the conditions as proposer in the plan should be fulnilled

The validity of the written permission to execute the work is subject to the above conditions

A suitable pump has to be provided i.e. pumping unfiltered water for the distribution to the flushing disterns and urinals in the building incess unfilers succession street main is not a come, a

Plan to the state of the state of the should be submitted at the Chapper the Ex-Engineer Water Supply and the sauction obtained before proceeding with the work of Water Supply any deviation may lead to disconnection/demolition.

CONSTRUCTION SITE SHALL BE MAINTAINED FREE FROM AIR POLLUTION ACCORDING TO UNDERTAKING SUBMITTED AS PER AMENDMENT OT, 31,01,01,01,016,100,95/MA/O/C-4/ 3R-7/2017 OF SCHEDULE-1105 MID EUILOING RULE 2009

Non Commencement of Erectiony Re-Erection within Five year will Require Fresh Application for Sanction

All Building Materials to necessary & construction should conform's to standered specified in the National Building Code of India.

Design of all Structural Members including that of the foundation should conform to Standards specified in the National Building Code of India.

DING DEPARTME

2 4 OCT 2019

01

CHECKED AND VERIFIED

Owton A.E.(C)/S.A.E.(C)

. MILLEL

for the safety of the lives of the adjoining public and private properties during construction.

Structural plan and design calculation as submitted by the structural engineer have been kept with B. P. No. 2019/96 record of the Kolkata Municipal Corporation and a verification No. deviation from the submitted structural for the ade at the time of eraction with reduced at the time of eraction and reduced at the time of eraction and reduced at the time of eraction and reduced at the time of the adjusting macross a publication properties and safety of human hid during construction

Asst. Engineer/Technical Advisor / Executive Engineer
BOROUGH NO.- XIII, XIV